VICINITY MAP

PROJECT DATA

SITE ADDRESS: 4027 93RD AVE SE, MERCER ISLAND, WA 98040 PARCEL: 003100-0095 PROPERTY OWNER: SAM CHUNG PHONE NUMBER: 415-202-3226 EMAIL: KATECHUNGHOMES@GMAIL.COM APPLICANT:STEVE JOO PHONE NUMBER:206-306-6738 EMAIL:STEVE.JOO@HOTMAIL.COM

LOT SIZE: 8,575 SQ. FT.

LEGAL DESCRIPTION: ACERSON PARK ADD 19 LESS N 28 FT & 42 FT OF 20 PLat Block: A Plat Lot: 19-20

LOT ZONING: R-8.4 MAXIMUM LOT COVERAGE(BUILDING AND DRIVING SURFACES): 40% (LOT SLOPE LESS THAN 15%) MAXIMUM GROSS FLOOR AREA: 40% MAXIMUM BUILDING HEIGHT: 30 FEET PROPOSED PÄRKING: 1 COVERED AND 1 UNCOVERED

1 COVERED STALL IS REQUIRED (UNDER 3,000 SQ. FT. GFA)

GROSS FLOOR AREA


LOT AREA	8,575 SQ. FT.
EXISTING FINISHED AREA	1,630 SQ. FT.
EXISTING GARAGE AREA CONVERGED TO LIVING AREA	480 SQ. FT.
PROPOSED ADDITION (DETACHTED GARAGE)	318 SQ. FT.
NEW GROSS FLOOR AREA	2,428 SQ. FT.
2,428 / 8,575 X 100 = 28.3%	

LOT COVERAGE

	EXISTING (HOUSE BUILT IN YEAR 1954)					
	ALL ROOVES(INCLUDING EAVES)	2,619 SQ. FT.				
	DRIVEWAY(ASPHALT)	893 SQ. FT.				
{	COVERED PATIO(CONCRETE)	0 SQ. FT.				
	TOTAL	3,512 SQ. FT.				


3,512 / 8,575 X 100 = 40.96% (HOUSE BUILT IN YEAR 1954)

PROPOSED						
ALL ROOVES(INCLUDING EAVES)	2,619 SQ. FT.					
DRIVEWAY(ASPHALT)	465 SQ. FT.					
DETACHED GARAGE ROOF WITHIN EXISTING DRIVEWAY FOOTPRINT	356 SQ. FT.					
COVERED PATIO(CONCRETE)	0 SQ. FT.					
TOTAL 3,440 SQ. FT.						
3,440 / 8,575 X 100 = 40.12%	3,440 / 8,575 X 100 = 40.12%					
NO NEW LOT COVERAGE IS PROPOSED. PROPOSED DETACHED GARAGE IS IN THE SAME FOOTPRINT OF THE EXISTING DRIVEWAY						

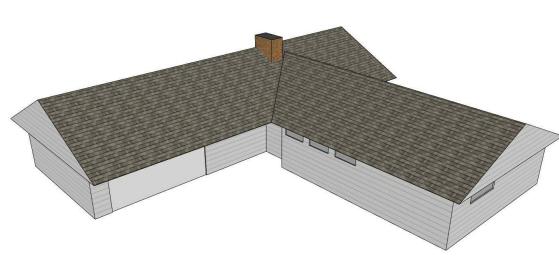

EXISTING HOUSE



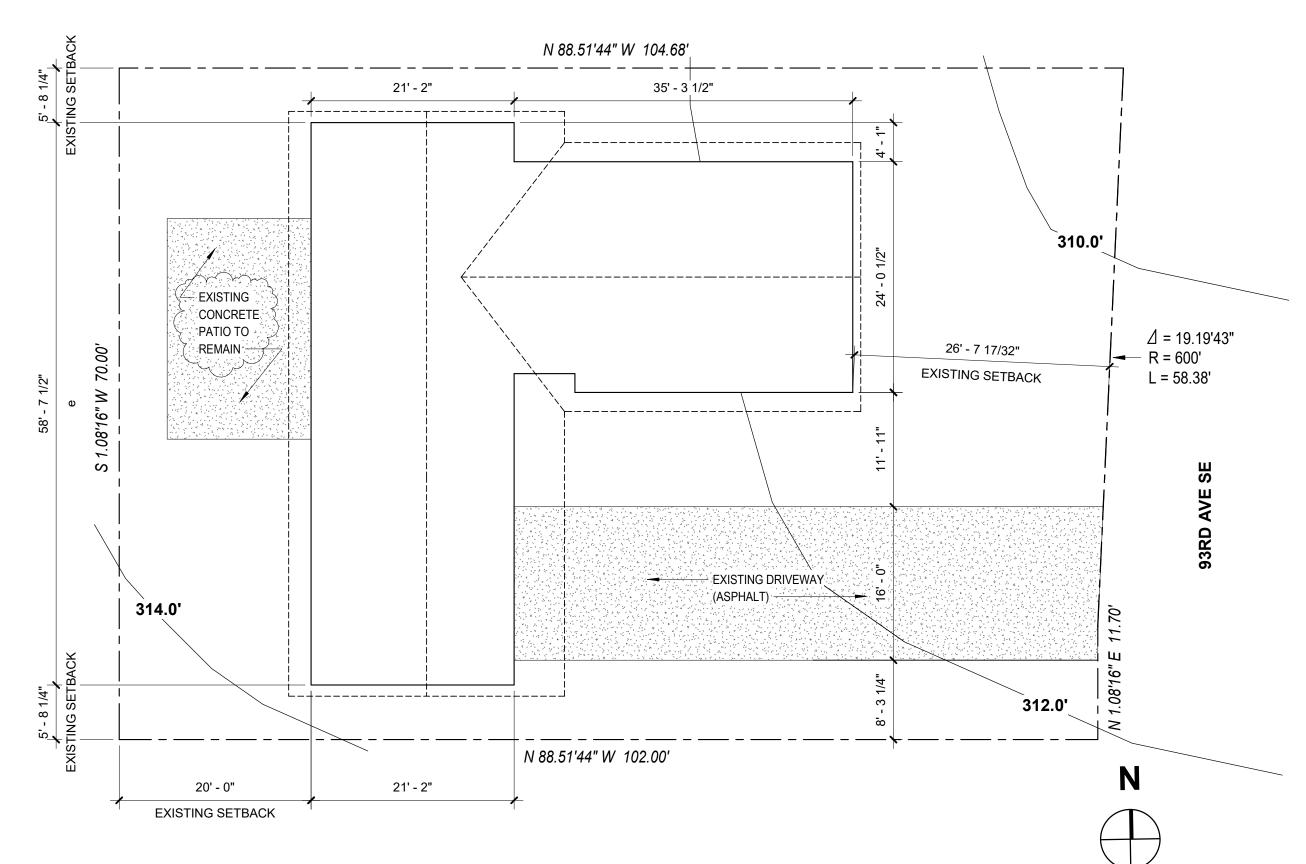

SITE PLAN EXISTING

LINETYPE LEGEND PROPERTY LINE FILTER FABRIC FENCE EXISTING GRADE LINE ----312.0'----

AVERAGE BUILDING ELEVATION 2 (ABE2)
PROPOSED DETACHED GARAGE **AVERAGE BUILDING ELEVATION 1 (ABE1) EXISTING HOUSE**

HVAC, PLUMBING, ELECTRICAL ARE UNDER SEPARATE PERMITS

= 22,484.95 / 71.98 = 312.38 feet

MIDPOINT ELEVATION	WALL SEGMENT LENGTH		MIDPOINT ELEVATION	WALL SEGMENT LENGT
J = 312.0 feet j = 15.99 feet			A = 311.5 feet	a = 24.04 feet
K = 312.5 feet	k = 20.00 feet		B = 312.4 feet	b = 35.29 feet
M = 312.7 feet	m = 15.99 feet n = 20.00 feet		C = 313.0 feet	c = 30.50 feet
N = 312.7 feet			D = 313.6 feet	d = 21.16 feet
11 - 20.00 feet			E = 313.3 feet	e = 58.63 feet
ABE =((312.0)(15.99)+(312.5)(20.00)+(312.7)(15.99)+ (312.3)(20.00) / (15.99+20.00+15.99+20.00) = 22.484.95 / 71.98			F = 312.7 feet	f = 21.16 feet
			G = 312.5 feet	g = 4.08 feet
			H = 312.2 feet	h = 35.29 feet

ABE =((311.5)(24.04)+(312.4)(35.29)+(313.0)(30.50)+ (313.6)(21.16)+(313.3)(58.63)+(312.7)(21.16)+ (312.5)(4.08)+(312.2)(35.29)) / (24.04+35.29+30.50+21.16+58.63+21.16+4.08+

= 71,973.38 / 230.15 = 312.72 feet

21' - 2" 35' - 3 1/2" EXISTING SETBACK N 88.51'44" W 104.68' DOWNSPOUT(TYP) 310.0' EXISTING HOUSE TO REMAIN =,EXISTING * **⊿** = 19.19'43" CONCRETE R = 600' 26' - 7 17/32" L = 58.38' EXISTING SETBACK - EXISTING ROOF OVERHANG $^{
m ^{
m 1}}$ - FILTER FABRIC FENCE NEW ROOF OVERHANG - LINE OF EXISTING GARAGE CONVERSION TO **EXISTING** PROPOSED ADDTITION DRIVEWAY M (DETACHED GARAGE) DRIVEWAY ,(ASPHALT). TO BE LIVING SPACE 314.0' REMOVED -20' - 0" 3' - 3 1/2" 🕏 N 88.51'44" W 102.00' 35' - 3 1/2" 21' - 2" EXISTING SETBACK

SITE PLAN PROPOSED

1" = 10'-0"

OWNER: **SAM CHUNG** 4027 93RD AVE SE MERCER ISLAND WA 98040 ARCHITECT: **STEVE JOO** 206-306-6738

steve.joo@hotmail.com STRUCTURAL ENGINEER: **SUNG CHO** 206-235-8886 sung.cho@cs2engineers.com

> **CHUNG RESIDENCE ADDITION**

4027 93RD AVE SE MERCER ISLAND WA

REGISTERED ARCHITECT SEKWANG JOO STATE OF WASHINGTON EXPIRES 04 / 10 / 2021

ISSUE MARK DATE DESCRIPTION Date 1 Revision 1

DRAWN BY: PROJ. ARCH.:

SITE PLAN & **TESC PLAN**

NOTE:
THE CONSTRUCTION DOCUMENTS REPRESENTED HEREIN ARE BASED ON NON-INVASIVE SITE OBSERVATION OF THE EXISTING STRUCTURAL CONDITIONS OF THE PROPOSED PROJECT. AS A RESULT, IN CERTAIN INSTANCES, DESIGN ASSUMPTIONS WERE USED TO FORMULATE THE COMPATIBILITY OF THE NEW CONSTRUCTION WITH THE EXISTING STRUCTURAL ELEMENTS. DURING THE COURSE OF CONSTRUCTION, IT IS POSSIBLE THAT CONDITIONS MAY BE ENCOUNTERED THAT DO NOT COINCIDE WITH THE DESIGN ASSUMPTIONS AND MAY REQUIRE FURTHER

STRUCTURAL REVIEW TO DETERMINE ADEQUACY. THE BUILDER SHALL BE OBSERVANT OF THESE CONDITIONS AND IMMEDIATELY REPORT ANY DISCREPANCIES TO THE ARCHITECT PRIOR TO PROCEEDING FURTHER WITH THE WORK.


GENERAL NOTES


- VERIFY IN THE FIELD ALL DIMENSIONS OF EXISTING CONDITION
- CONSTRUCTION TO COMPLY WITH THE 2015 IRC
- NEW 2X6 EXTERIOR STUD WALLS @ 24" O.C. STACKED FRAMED
- NEW 2X4 INTERIOR STUD WALLS @ 16" O.C. UNLESS NOTED OTHERWISE
- BEARING AND HEADERS TO BE 6X8 #2 DF OR 4X10 #2 DF FURRED-OUT
- FIREBLOCK ALL PLUMBING PENETRATIONS

- PROVIDE SOLID BLOCKING OVER BEAMS & BEARING WALLS
- ALL HANGER TO BE SIMPSON OR EQUAL
- BEDROOMS TO HAVE AT LEAST ONE OPERABLE WINDOW NET CLEAR
OPENING OF 5.7 SQ. FT. MIN. WITH A NET CLEAR OPENING HT. OF 24" MIN.
AND NET CLEAR OPENING WIDTH OF 20" MIN. AND A FINISHED SILL HEIGHT

OF NOT MORE THAN 44" ABOVE FINISH FLOOR.
- FIREPLACES AND STOVES MUST BE D.O.E. APPROVED AND BE TESTED,
CERTIFIED & LABELED AS SUITABLE FOR USE DURING A FIRST STAGE BURN
BAN

- ALL LUMBER EXPOSED TO WEATHER OR CONCRETE TO BE PRESSURE TRESTED OR CEDAR

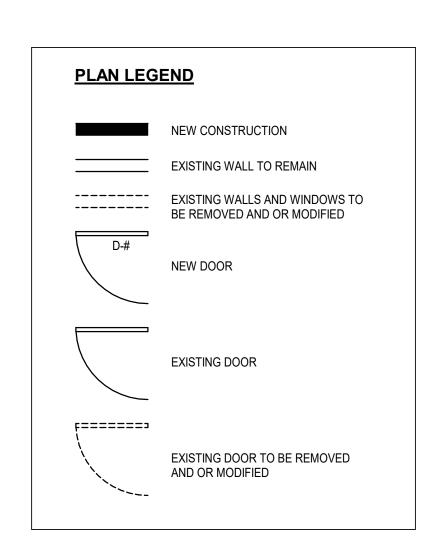

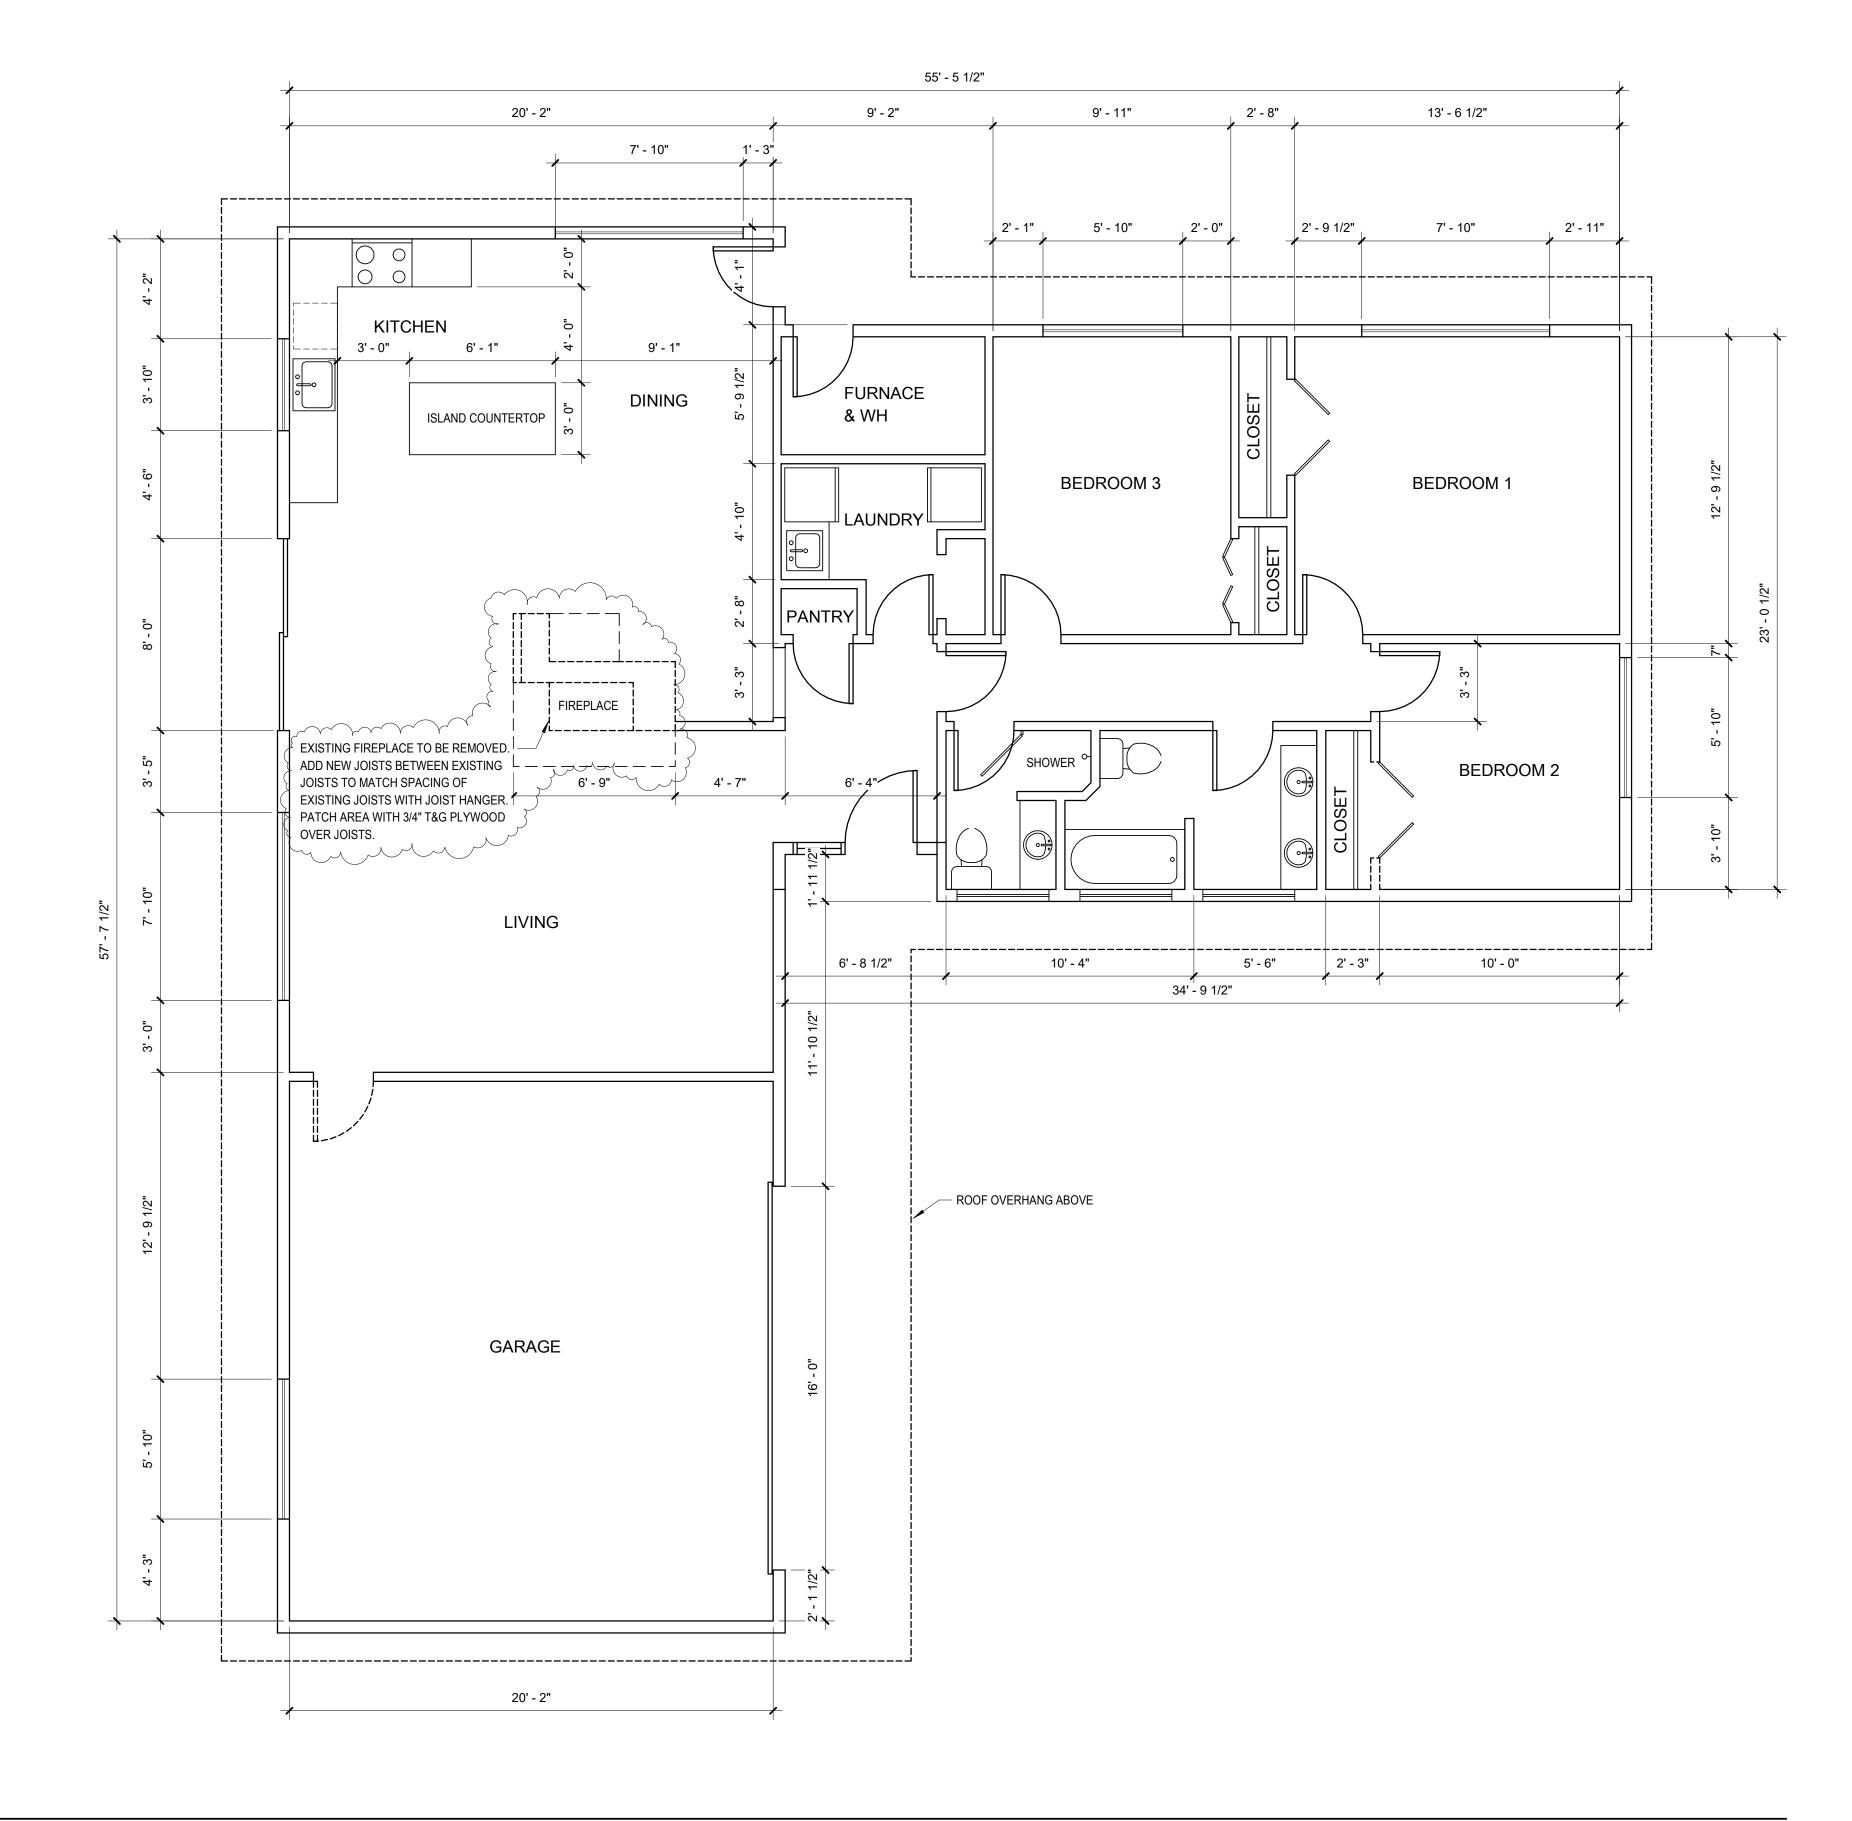

1 EXISTING FLOOR PLAN



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CHUNG RESIDENCE ADDITION

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EXISTING FLOOR PLAN

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A-2


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- VERIFY IN THE FIELD ALL DIMENSIONS OF EXISTING CONDITION - CONSTRUCTION TO COMPLY WITH THE 2015 IRC - NEW 2X6 EXTERIOR STUD WALLS @ 24" O.C. STACKED FRAMED - NEW 2X4 INTERIOR STUD WALLS @ 16" O.C. UNLESS NOTED OTHERWISE - BEARING AND HEADERS TO BE 6X8 #2 DF OR 4X10 #2 DF FURRED-OUT - FIREBLOCK ALL PLUMBING PENETRATIONS

- PROVIDE SOLID BLOCKING OVER BEAMS & BEARING WALLS - ALL HANGER TO BE SIMPSON OR EQUAL

- BEDROOMS TO HAVE AT LEAST ONE OPERABLE WINDOW NET CLEAR OPENING OF 5.7 SQ. FT. MIN. WITH A NET CLEAR OPENING HT. OF 24" MIN. AND NET CLEAR OPENING WIDTH OF 20" MIN. AND A FINISHED SILL HEIGHT OF NOT MORE THAN 44" ABOVE FINISH FLOOR.

- ALL LUMBER EXPOSED TO WEATHER OR CONCRETE TO BE PRESSURE TRESTED OR CEDAR

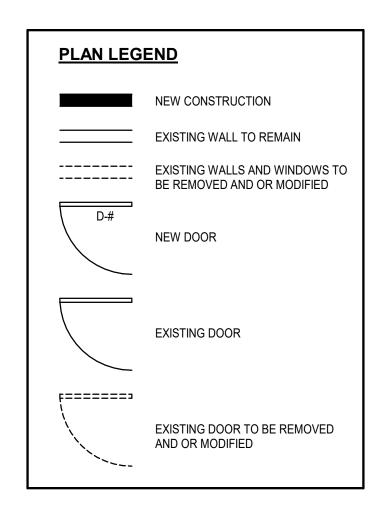

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SQUARE FOOTAGE

	EXISTING			PROPOSED			
	LIVING AREA	GARAGE	SUBTOTAL	LIVING AREA	GARAGE	SUBTOTAL	
1ST FLOOR	1,630	480	2,110	2,110	318	2,428	

SHEAR WALL SCHEDULE

	MARK	SHEATHING COMMON	STUDS AT ABUTTING PANEL	PANEL EDGE NAILING	RIM JOIST OR BLOCKING ATTACHMENT TO TOP PLATE		2X BOTTOM PLATE ATTACHMENT	SILL PLATE A	TTACHMENT
			EDGES*	**/****	SOLID RIM	TJI RIM	BOTTOM PLATE TO RIM JOIST BELOW**	ANCHOR BOLT TO CONCRETE ***	SILL PLATE AT FOUND.
	SW1	7/16" OSB ONE SIDE	2X	8d @ 6" O.C.	A35 @ 24" O.C.	16d @ 6" O.C.	16d @ 6" O.C.	5/8" DIA. @ 48" O.C.	2X
(

* INTERMEDIATE FRAMING TO BE 2x STUDS. TWO 2x STUDS MAY BE USED IN PLACE OF 3x STUDS; NAIL TOGETHER WITH BOTTOM ** 8d NAILS SHALL BE 0.131" DIA X 2 1/2" (COMMON). 16d NAILS SHALL BE 0.135" DIA X 3 1/2" (BOX).

*** USE ANCHOR BOLT WITH 7" MIN. EMBED OR EXPANSION BOLTS WITH 4" EMBED. AT ALL ANCHOR BOLTS USE 3"X3"X1/4" PLATE

WASHERS (SIMPSON BP5/8-3 OR EQUAL) **** TWO STUDS MINIMUM ARE REQUIRED AT EACH END OF SHEARWALLS. END STUD SHALL RECEIVE PANEL EDGE NAILING.

WSEC - ENERGY EFFICIENCY CREDITS


SELECTED OPTIONS	DESCRIPTION	CREDIT
EFFICIENT BUILDING ENVELOPE 1a:	VERTICAL PENESTRATION U=0.28, FLOOR R=38	0.5
HIGH EFFICIENCY HVAC EQUIPMENT 3a:	GAS FURNACE W/ MINIMUM AFUE OF 94%	1.0
EFFICIENT WATER HEATING 5a:	KITCHEN SINK FAUCET AND SHOWERHEAD AT 1.75 GPM OR LESS	0.5
EFFICIENT WATER HEATING 5c:	GAS WATER HEATER W/ MINIMUM EF 0.91	1.5

WHOLE HOUSE FAN

	BATHROOM (3)	.25 w.g.	50 CFM					
	LAUNDRY	.25 w.g.	50 CFM					
	KITCHEN	.10 w.g.	100 CFM					
	BEDROOM (4)	.25 w.g.	50 CFM					
4	PROVIDE 150 CFM W.H.	F. WITH A 2	4 HOUR TIMER					
{	TO CONTROL EXHAUST FAN. INTERMITTENT AIR FLOW AT 50% RUN TIME.							
>								
كم	VENTILATION PATH THE	ROUGH UN	DERCUT DOOR.					
,	Υ							


DOOR SCHEDULE

DOOR	TYPE	SIZE		MATERIAL	DETAIL		U-VALUE
NUMBER		WIDTH	HEIGHT	MATERIAL	HEAD	JAMB	
D-01	SWING / SINGLE / PANEL	2'-6"	6'-8"	WOOD	4/A-14	5/A-14	
D-02	SWING / SINGLE / PANEL	2'-10"	6'-8"	WOOD			
D-03	OVERHEAD GARAGE DOOR	10'-0"	7'-0"	STEEL			

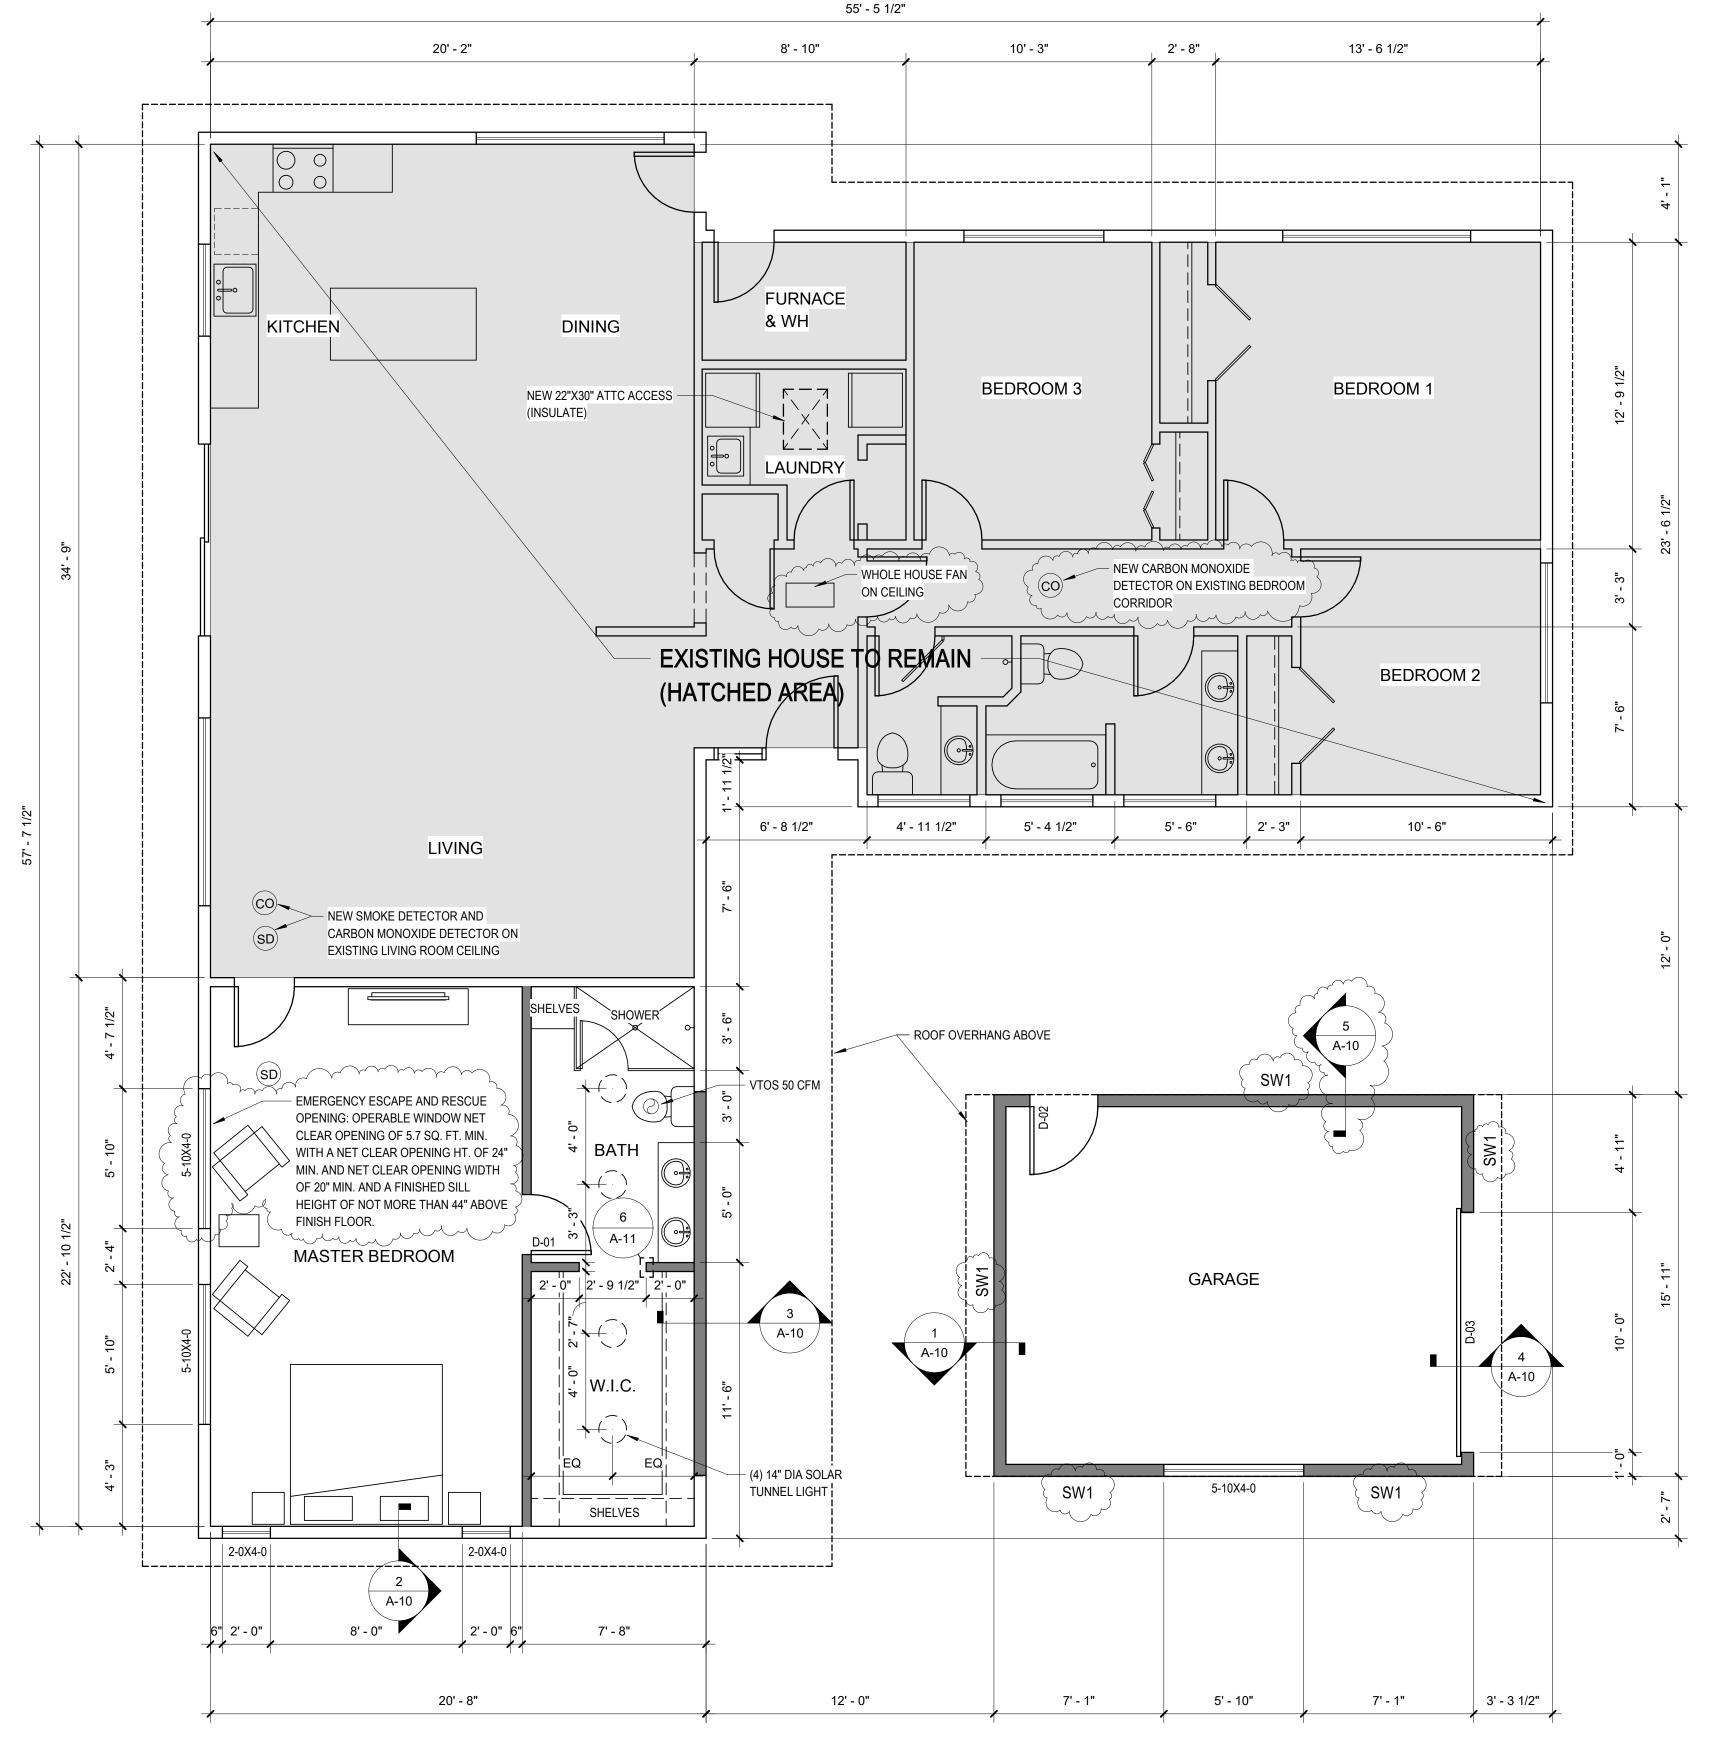

PROPOSED FLOOR PLAN

1/4" = 1'-0"

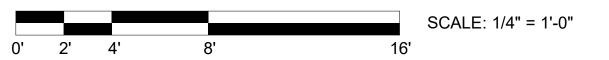

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CHUNG

sung.cho@cs2engineers.com

ADDITION 4027 93RD AVE SE MERCER ISLAND WA

RESIDENCE

98040

REGISTERED SEKWANG JOO STATE OF WASHINGTON

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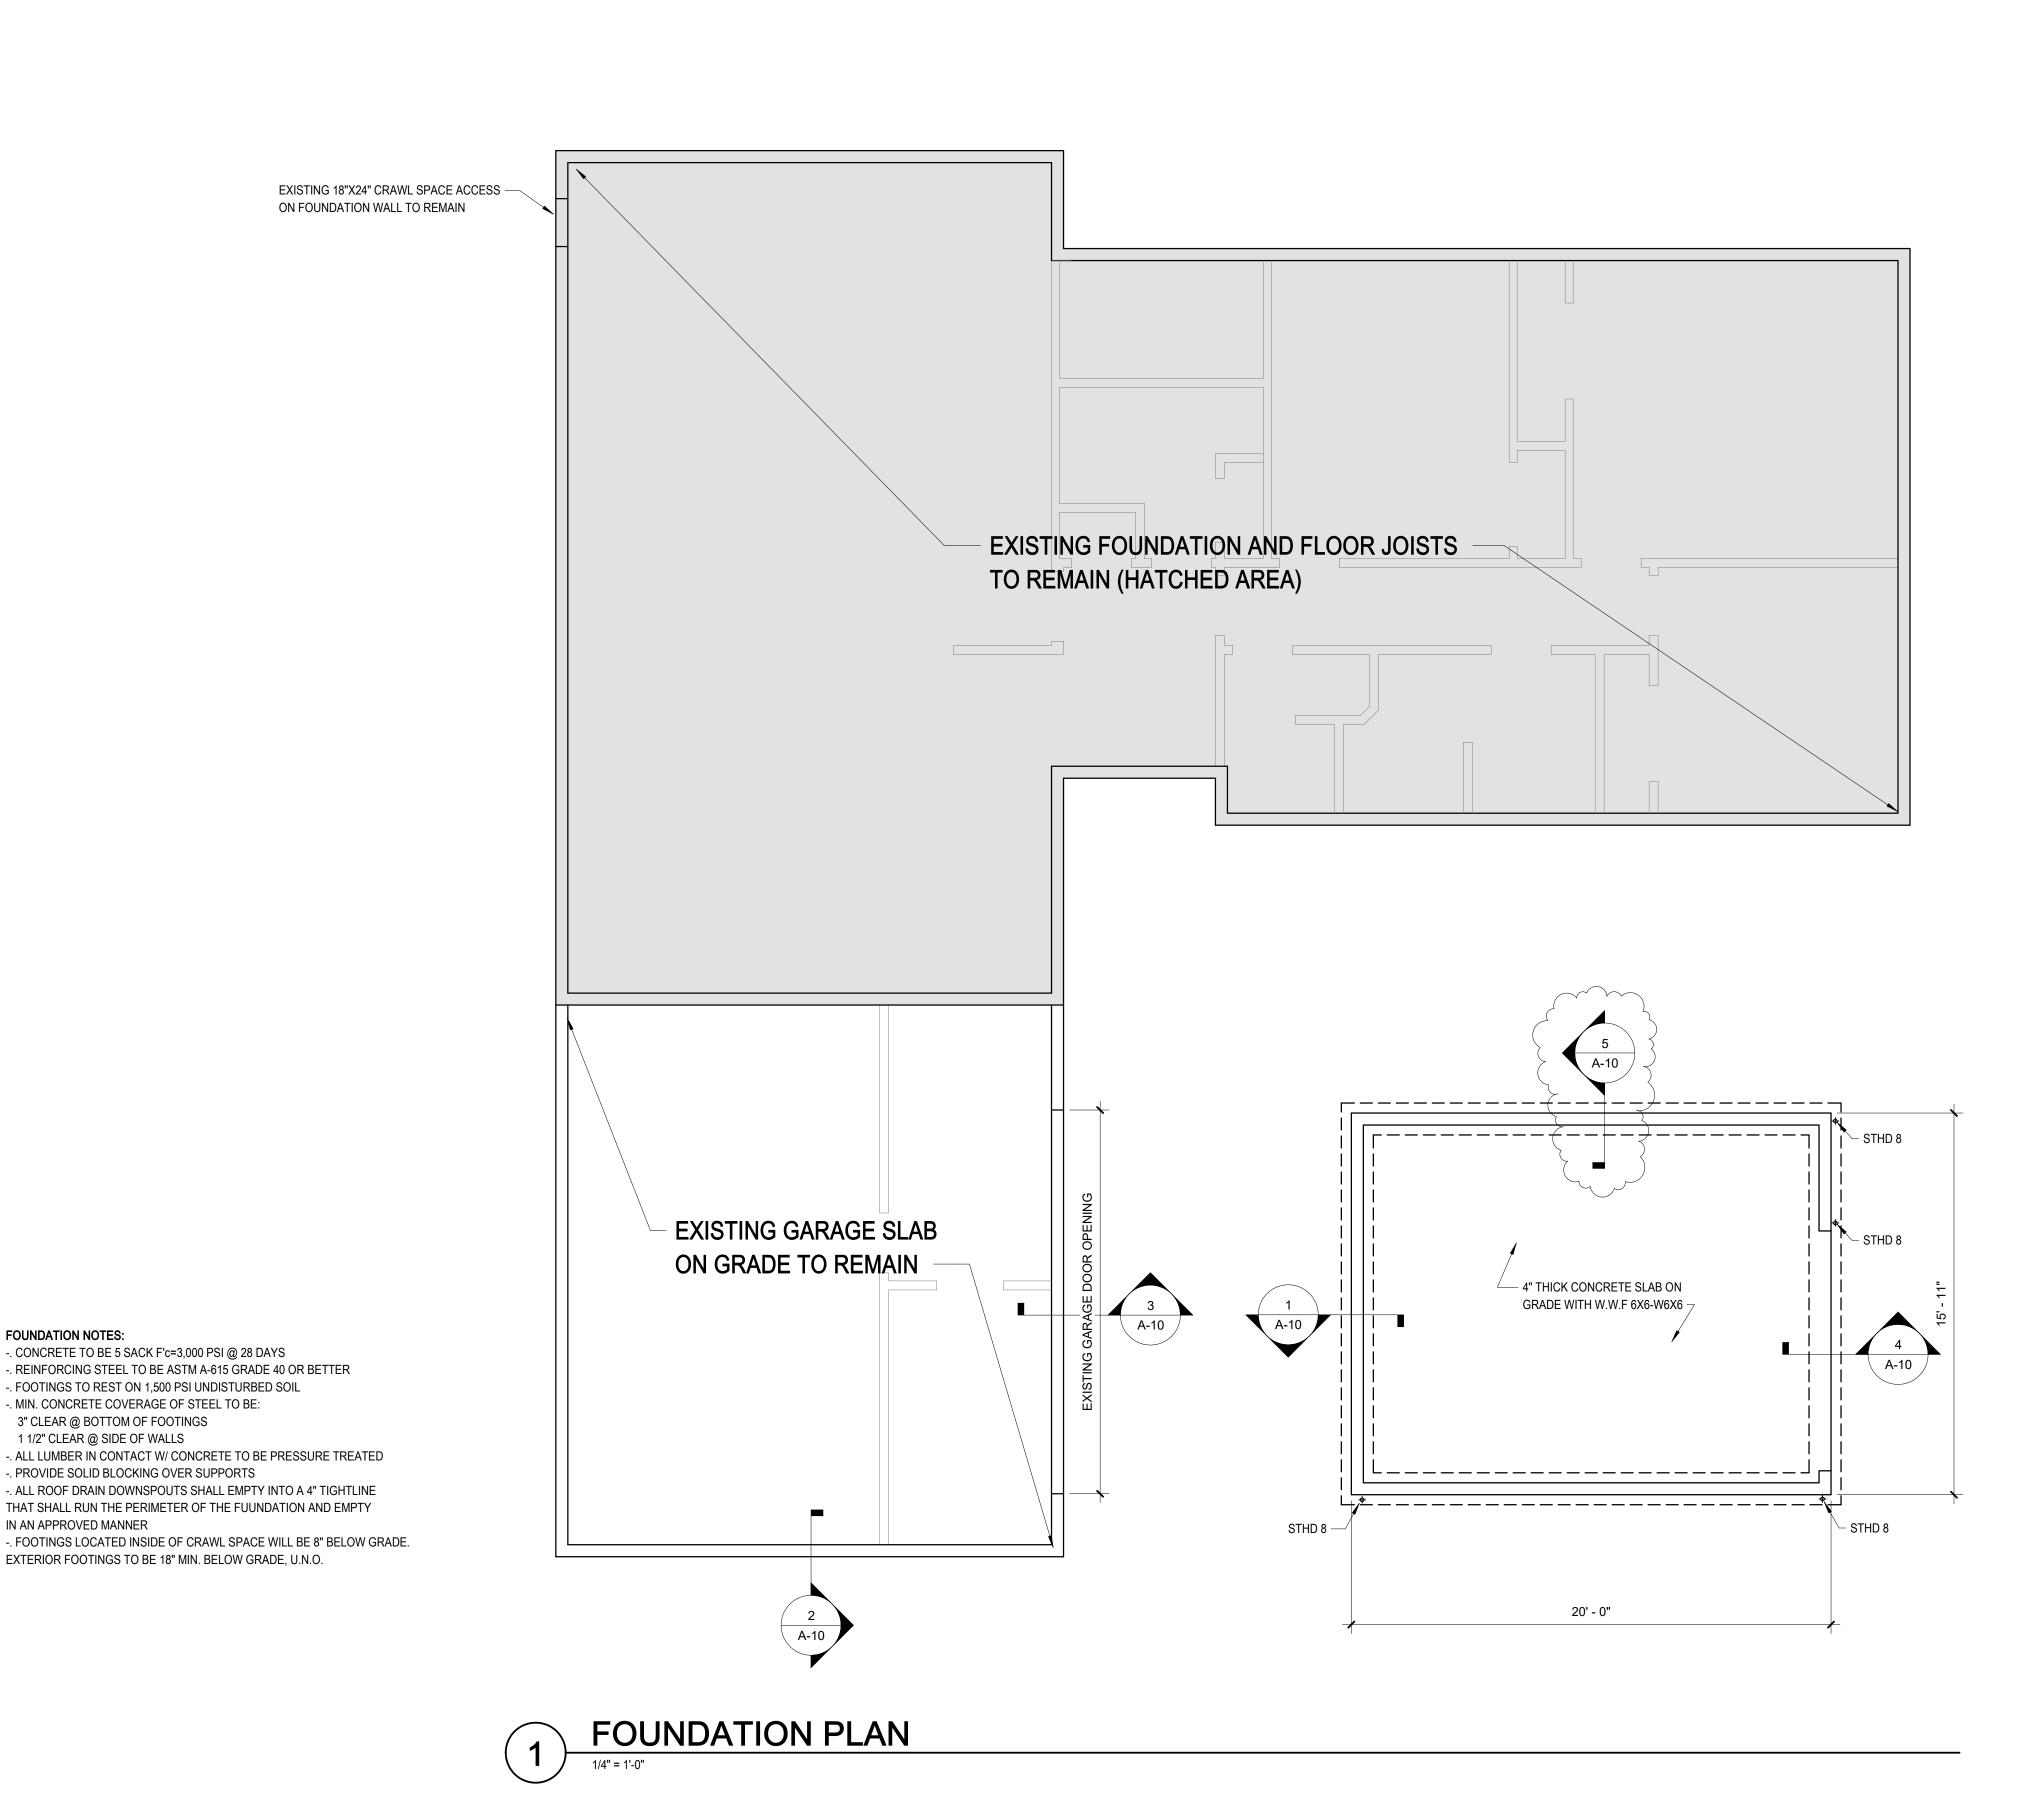
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12/17/2016

PROPOSED FLOOR PLAN



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CHUNG RESIDENCE **ADDITION**

4027 93RD AVE SE MERCER ISLAND WA 98040

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MARK	DATE	DESCRIPTION	
1	04/29/2017	STRUCTURAL REVIE	=
1	Date 1	Revision 1	
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3/15/2017

FOUNDATION **PLAN**

FOUNDATION NOTES:

-. CONCRETE TO BE 5 SACK F'c=3,000 PSI @ 28 DAYS

-. PROVIDE SOLID BLOCKING OVER SUPPORTS

3" CLEAR @ BOTTOM OF FOOTINGS 1 1/2" CLEAR @ SIDE OF WALLS

IN AN APPROVED MANNER

-. FOOTINGS TO REST ON 1,500 PSI UNDISTURBED SOIL -. MIN. CONCRETE COVERAGE OF STEEL TO BE:

-. REINFORCING STEEL TO BE ASTM A-615 GRADE 40 OR BETTER

-. ALL ROOF DRAIN DOWNSPOUTS SHALL EMPTY INTO A 4" TIGHTLINE

THAT SHALL RUN THE PERIMETER OF THE FUUNDATION AND EMPTY

EXTERIOR FOOTINGS TO BE 18" MIN. BELOW GRADE, U.N.O.

EXISTING SKYLIGHT EXISTING EXISTING ROOF ROOF VENT VENT 22"X30" ATTC ACCESS _(INSULATE) RIDGE EXISTING ROOF VENT — EXISTING CHIMNEY TO BE REMOVED PATCH AREA WITH COMPOSITE ROOFING OVER #15 WATERPROOF BUILDING PAPER OVER 7/16" OSB STRUCTURAL 1 RATED SHEATHING. ¹² EXISTING ROOF FRAMING TO REMAIN (HATCHED AREA) EXISTING ROOF VENT 5:12 EXISTING V.I.F. 5:12 EXISTING V.I.F. 4" EXHAUST VENT JACK EXISTING ROOF VENT EXISTING ROOF VENT (4) 14" DIA SOLAR TUNNEL LIGHT 4X10 DF#2 4X10 DF#2 4X10 DF#2

GENERAL NOTES:

- VERIFY IN THE FIELD ALL DIMENSIONS FOR EXISTING CONDITION
- ALL HEADERS TO BE 6X8 DF#2 OR 4X10 DF#2 UNLESS NOTED OTHERWISE.
- ALL LUMBER EXPOSED TO WEATHER TO BE PRESSURE TREATED OR CEDAR.
- SKYLIGHTS IN HEATED ENVELOP TO BE INSULATED PER WSEC.
- MIN. 22"X30" ATTIC ACCESS W/ 36" MIN. HEAD ROOM. INSULATE AND WEATHERSTRIP.
- FIREBLOCK ALL VOIDS.

TRUSS NOTES:

SHALL HAVE MANUFACTURER'S STAMP.
SHALL BE INSTALLED AND BRACED PER MANUFACTURER'S INSTRUCTIONS.
WILL NOT BE FIELD ALTERED WITHOUT BUILDING DEPARTMENT APPROVAL OF THE ENGINEERING CALCULATIONS.

- SHALL HAVE DESIGN DETAILS AND DRAWINGS ON SITE.

TRUSS HOLDDOWN:

SIMPSON H8 HURRICANE TIE-G90 GALVANIZED AT EACH TRUSS

ROOF NOTES:

MATERIAL: COMP ROOFING
PITCH: 5:12
OVERHANG: SEE DIMENSIONS ON PLAN

FASCIA: 1"X6" PRIMED AND PAINTED SPRUCE FASCIA BOARD, 1"X8" PRIMED AND PAINTED SPRUCE FASCIA BOARD AT GABLE

ATTIC VENTILATION: EXISTING HOUSE:

EXITING ATTIC VENTS TO REMAIN.

NEW GARAGE:

356 SQ. FT.(ATTIC SPACE) X 144/300 = 170.88 SQ. IN.(REQUIRED NET AREA) PROVIDE (10) 7.85 SQ. IN. VENT BLOCKS = 78.5 SQ. IN. PROVIDE (2) AF-50 ROOF JACKS = 100 SQ. IN.

IRC SECTION R806.2

ROOF FRAMING PLAN

1/4" = 1'-0"

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CHUNG RESIDENCE ADDITION

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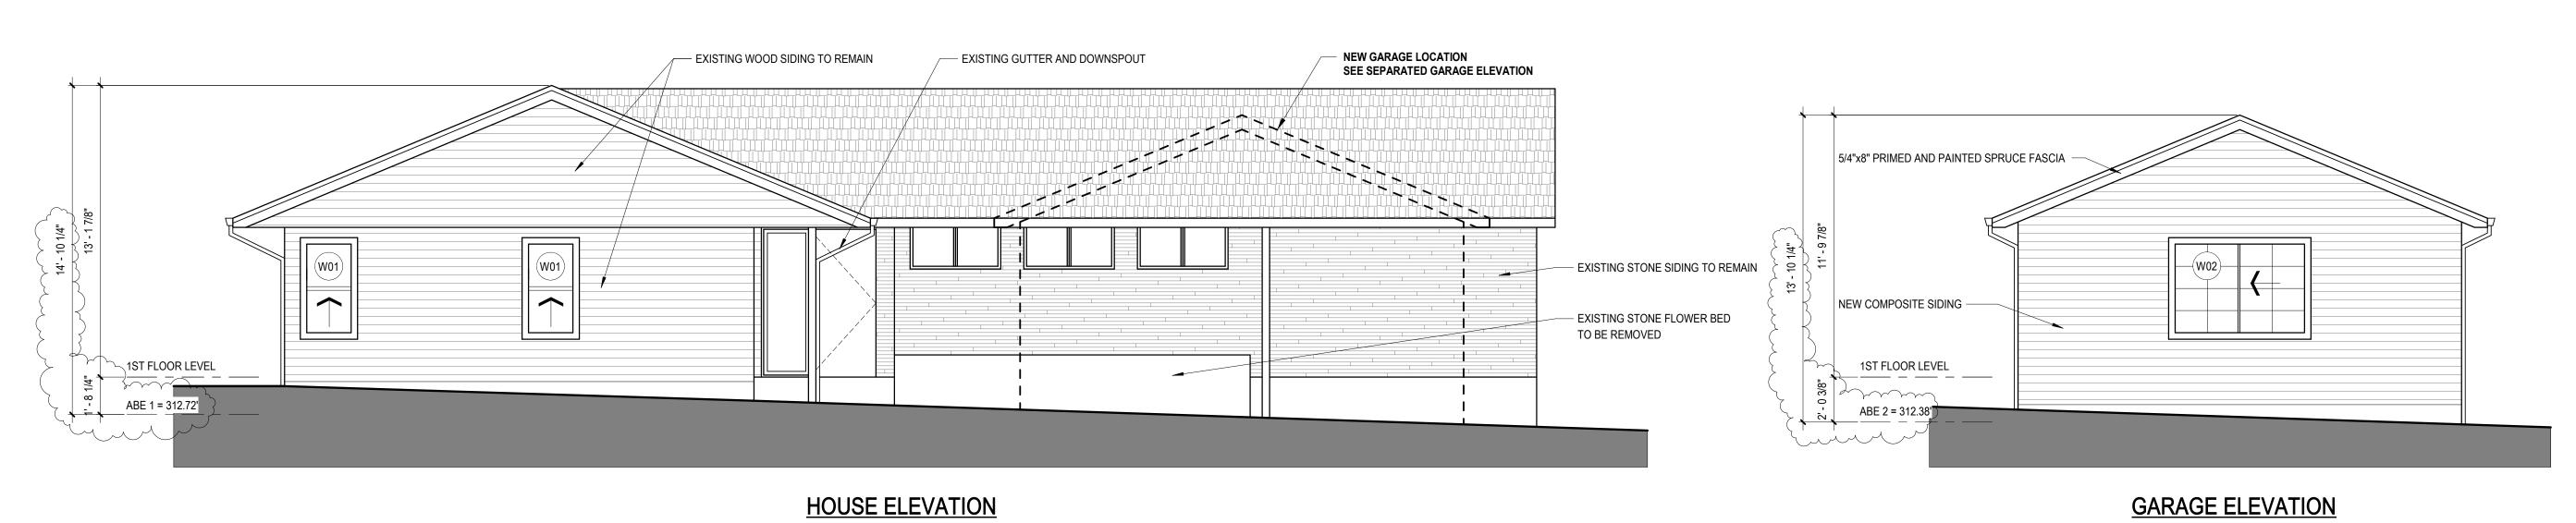
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DATE: **12/17/**

DWG


ROOF FRAMING PLAN

DWG.



BUILDING ELEVATION SOUTH - PROPOSED

1/4" = 1'-0"

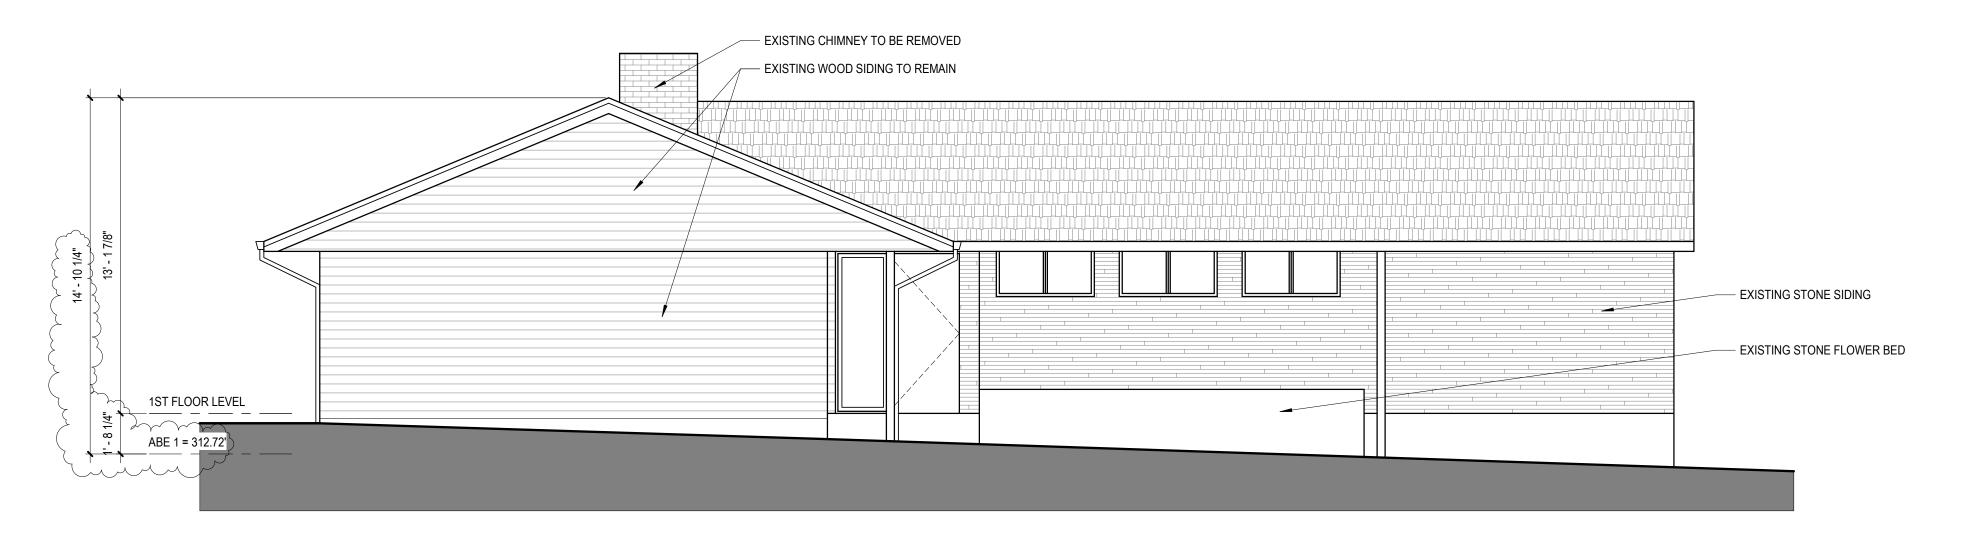

WINDOW LEGEND

NEW WINDOW

EXISTING WINDOW

NOTE:

1. SEE SHEET A-1 FOR AVERAGE BUILDING ELEVATION CALCULATION.
2. SEE SHEET A-14 FOR WINDOW SCHEDULE

1 BUILDING ELEVATION SOUTH - EXISTING

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CHUNG RESIDENCE ADDITION

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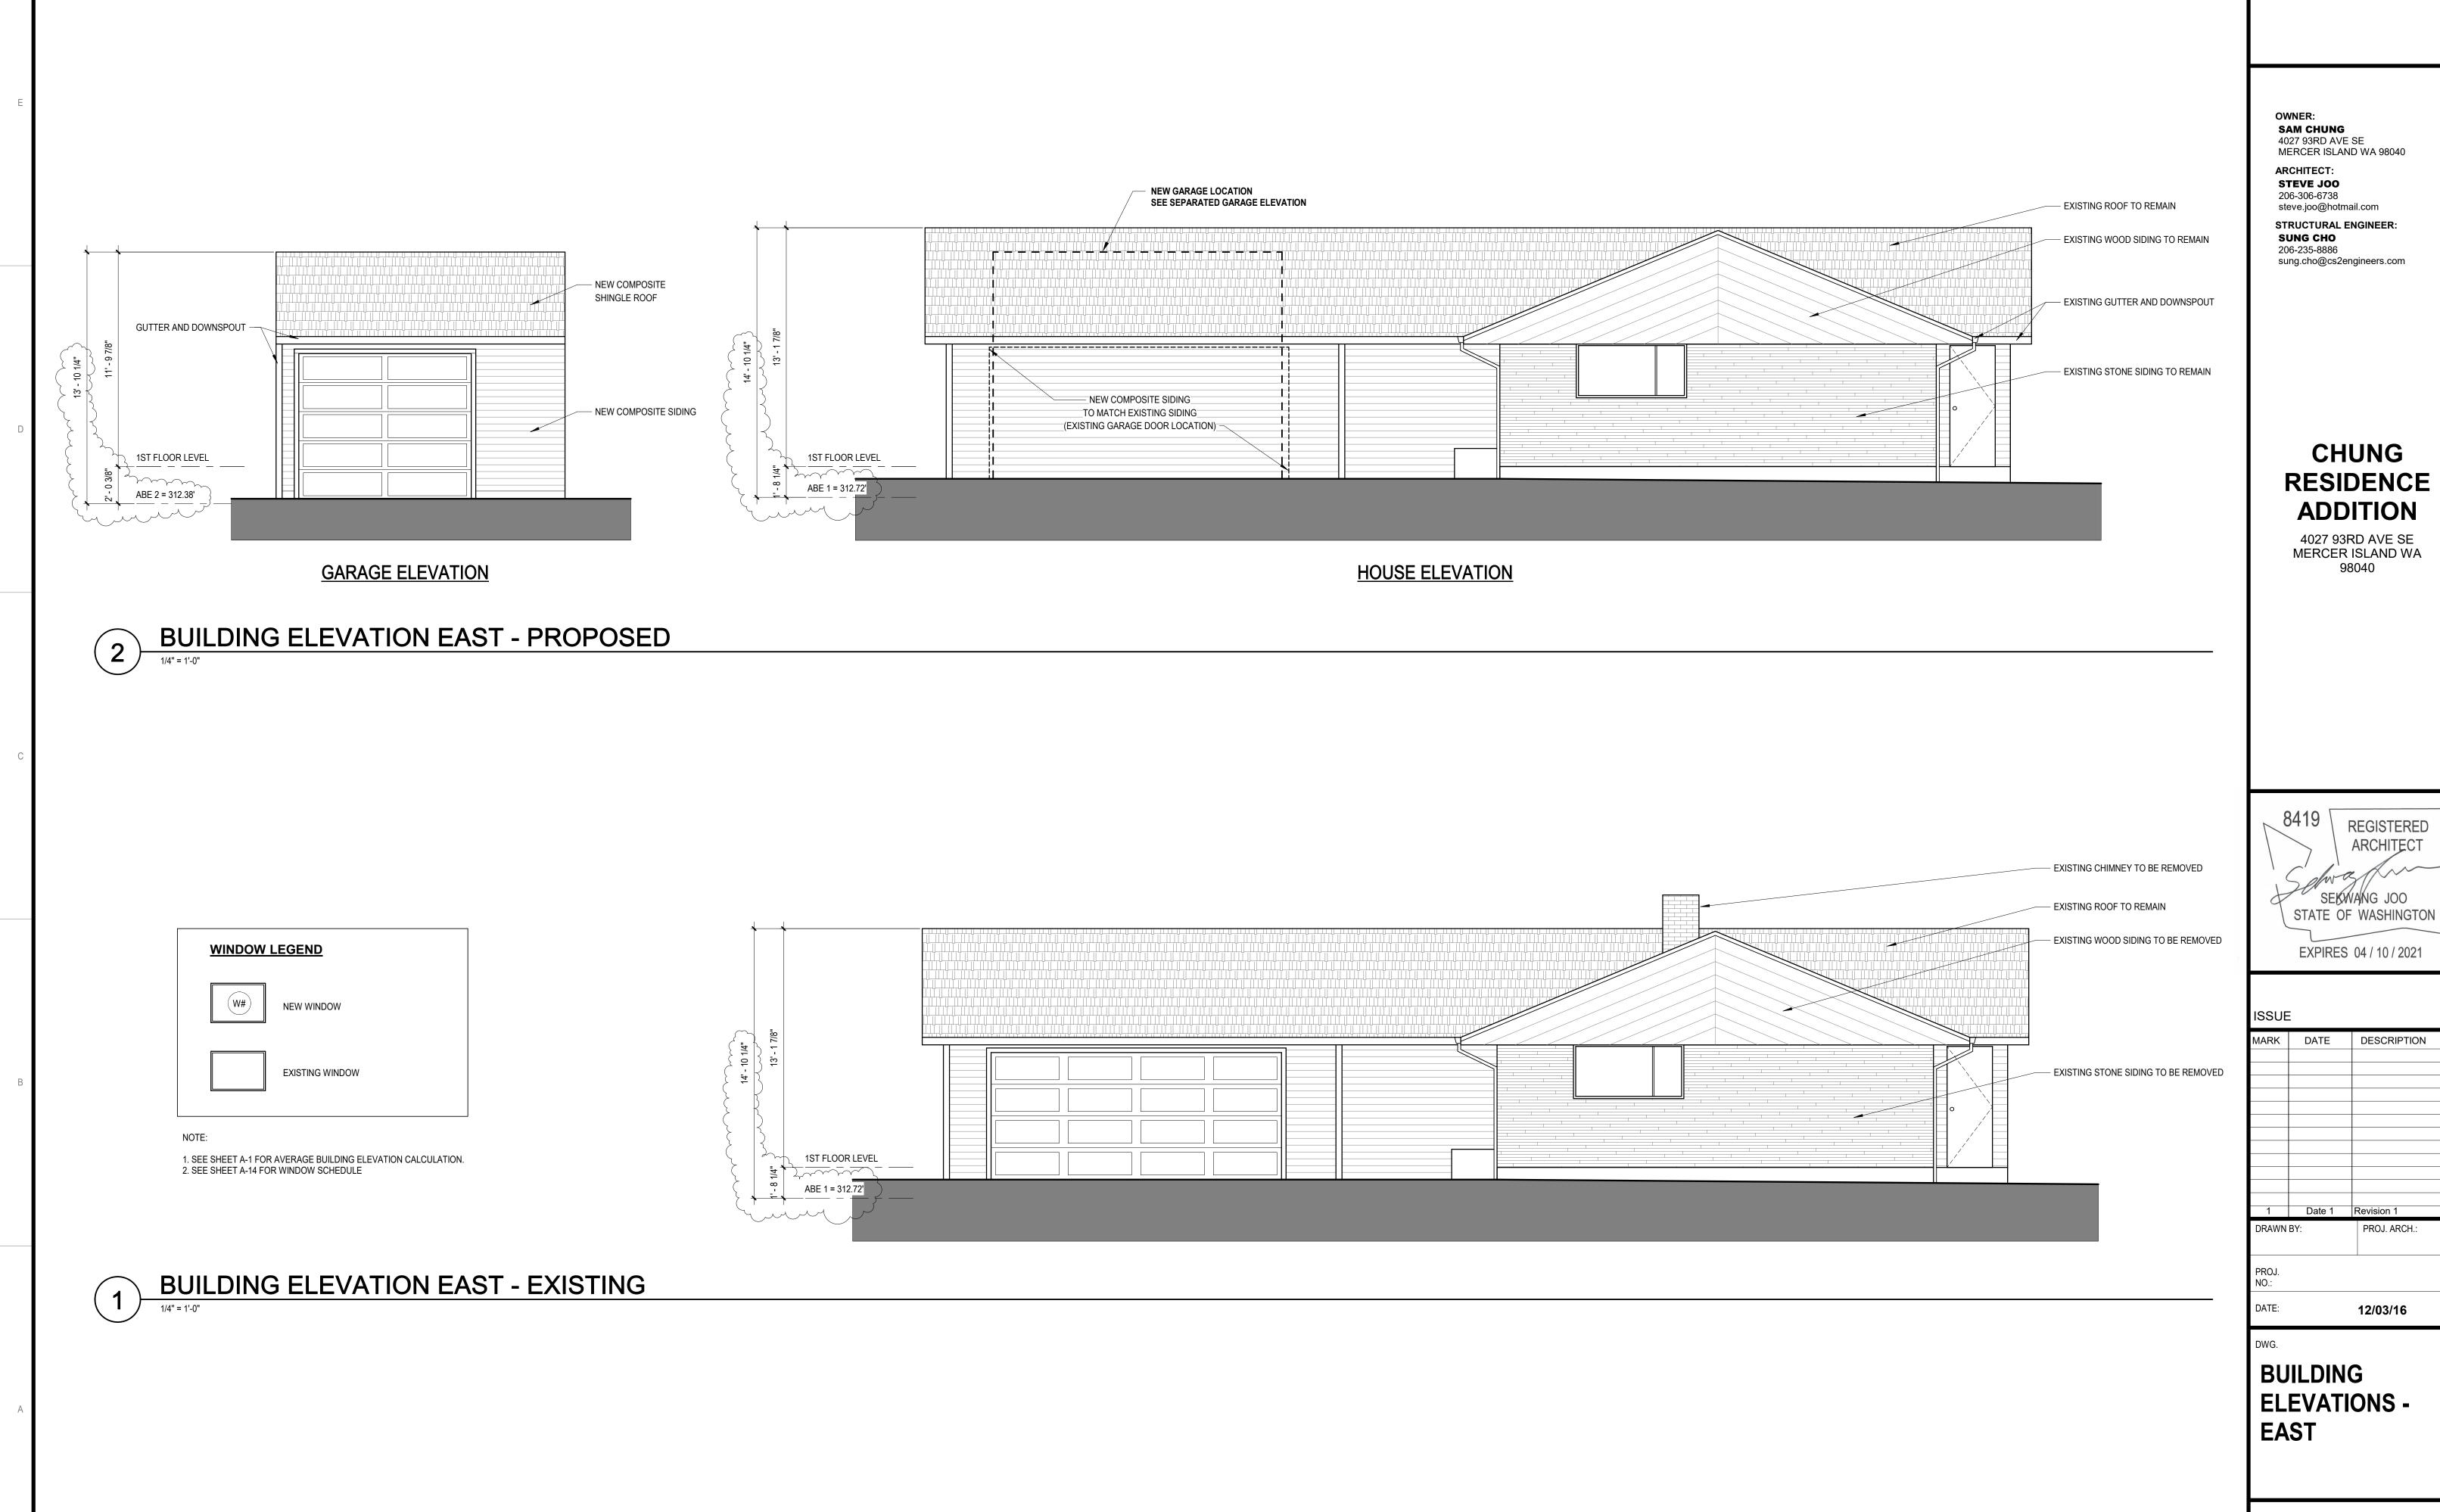
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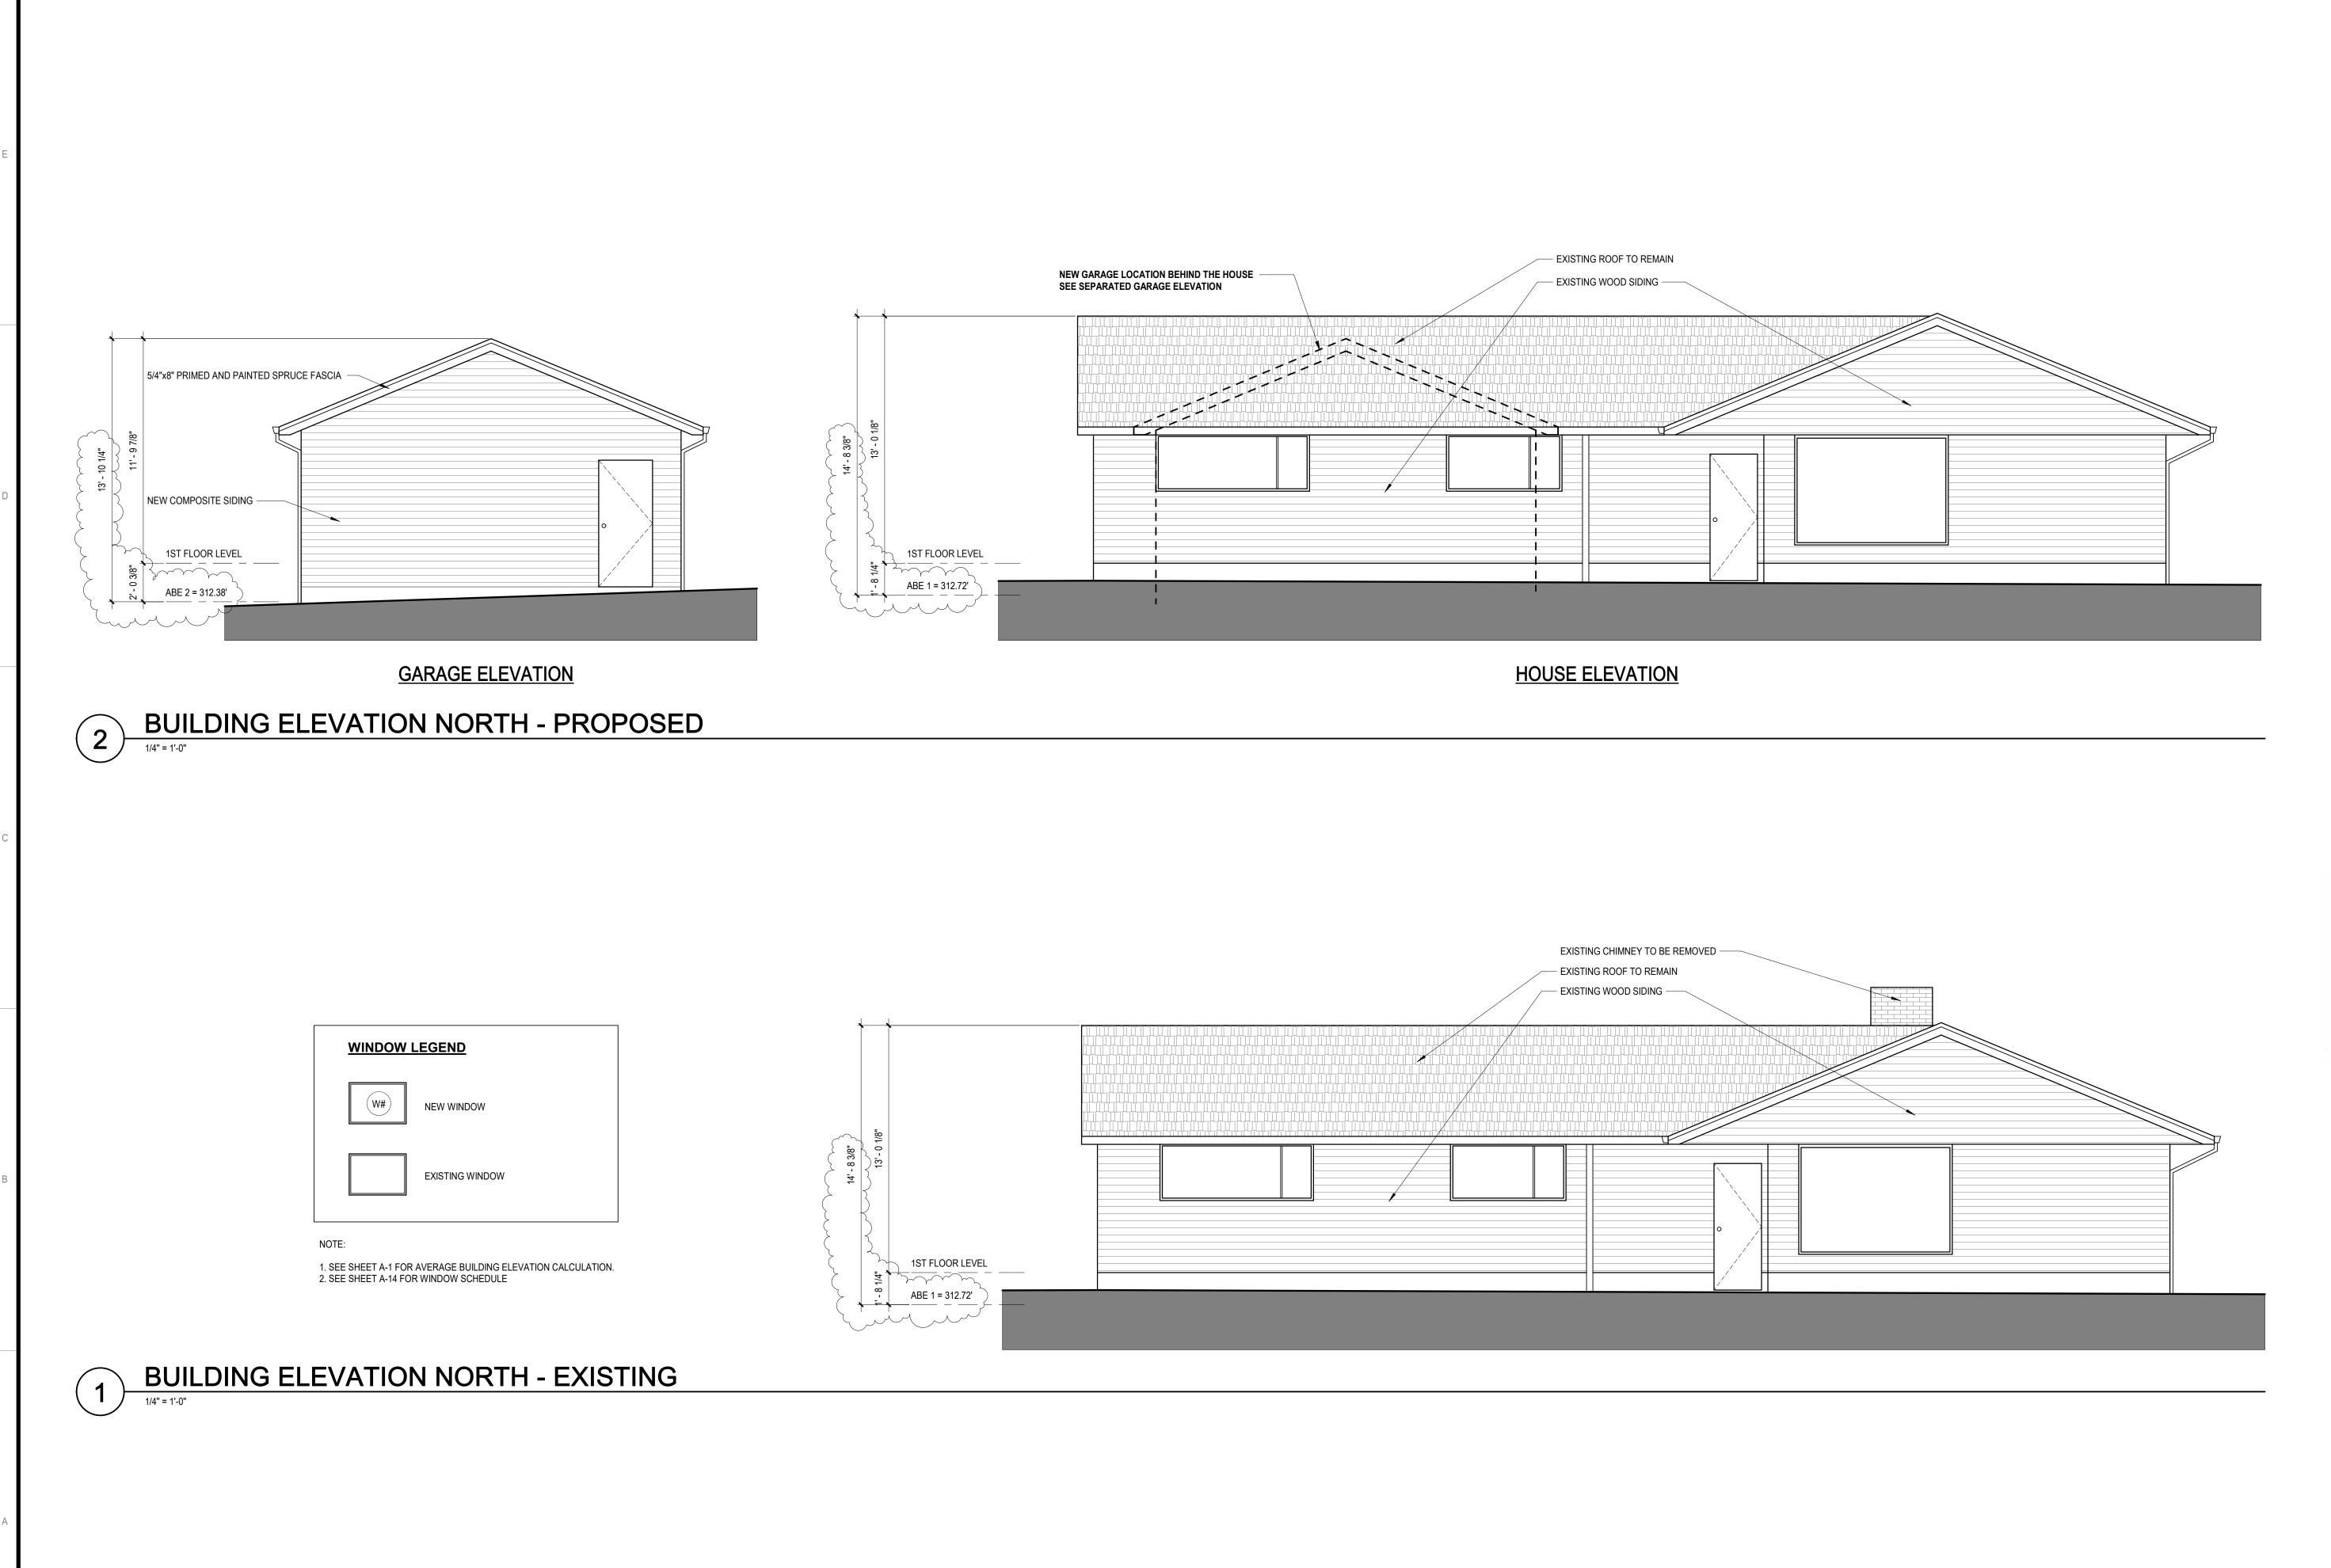
BUILDING ELEVATIONS -SOUTH

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REGISTERED STATE OF WASHINGTON



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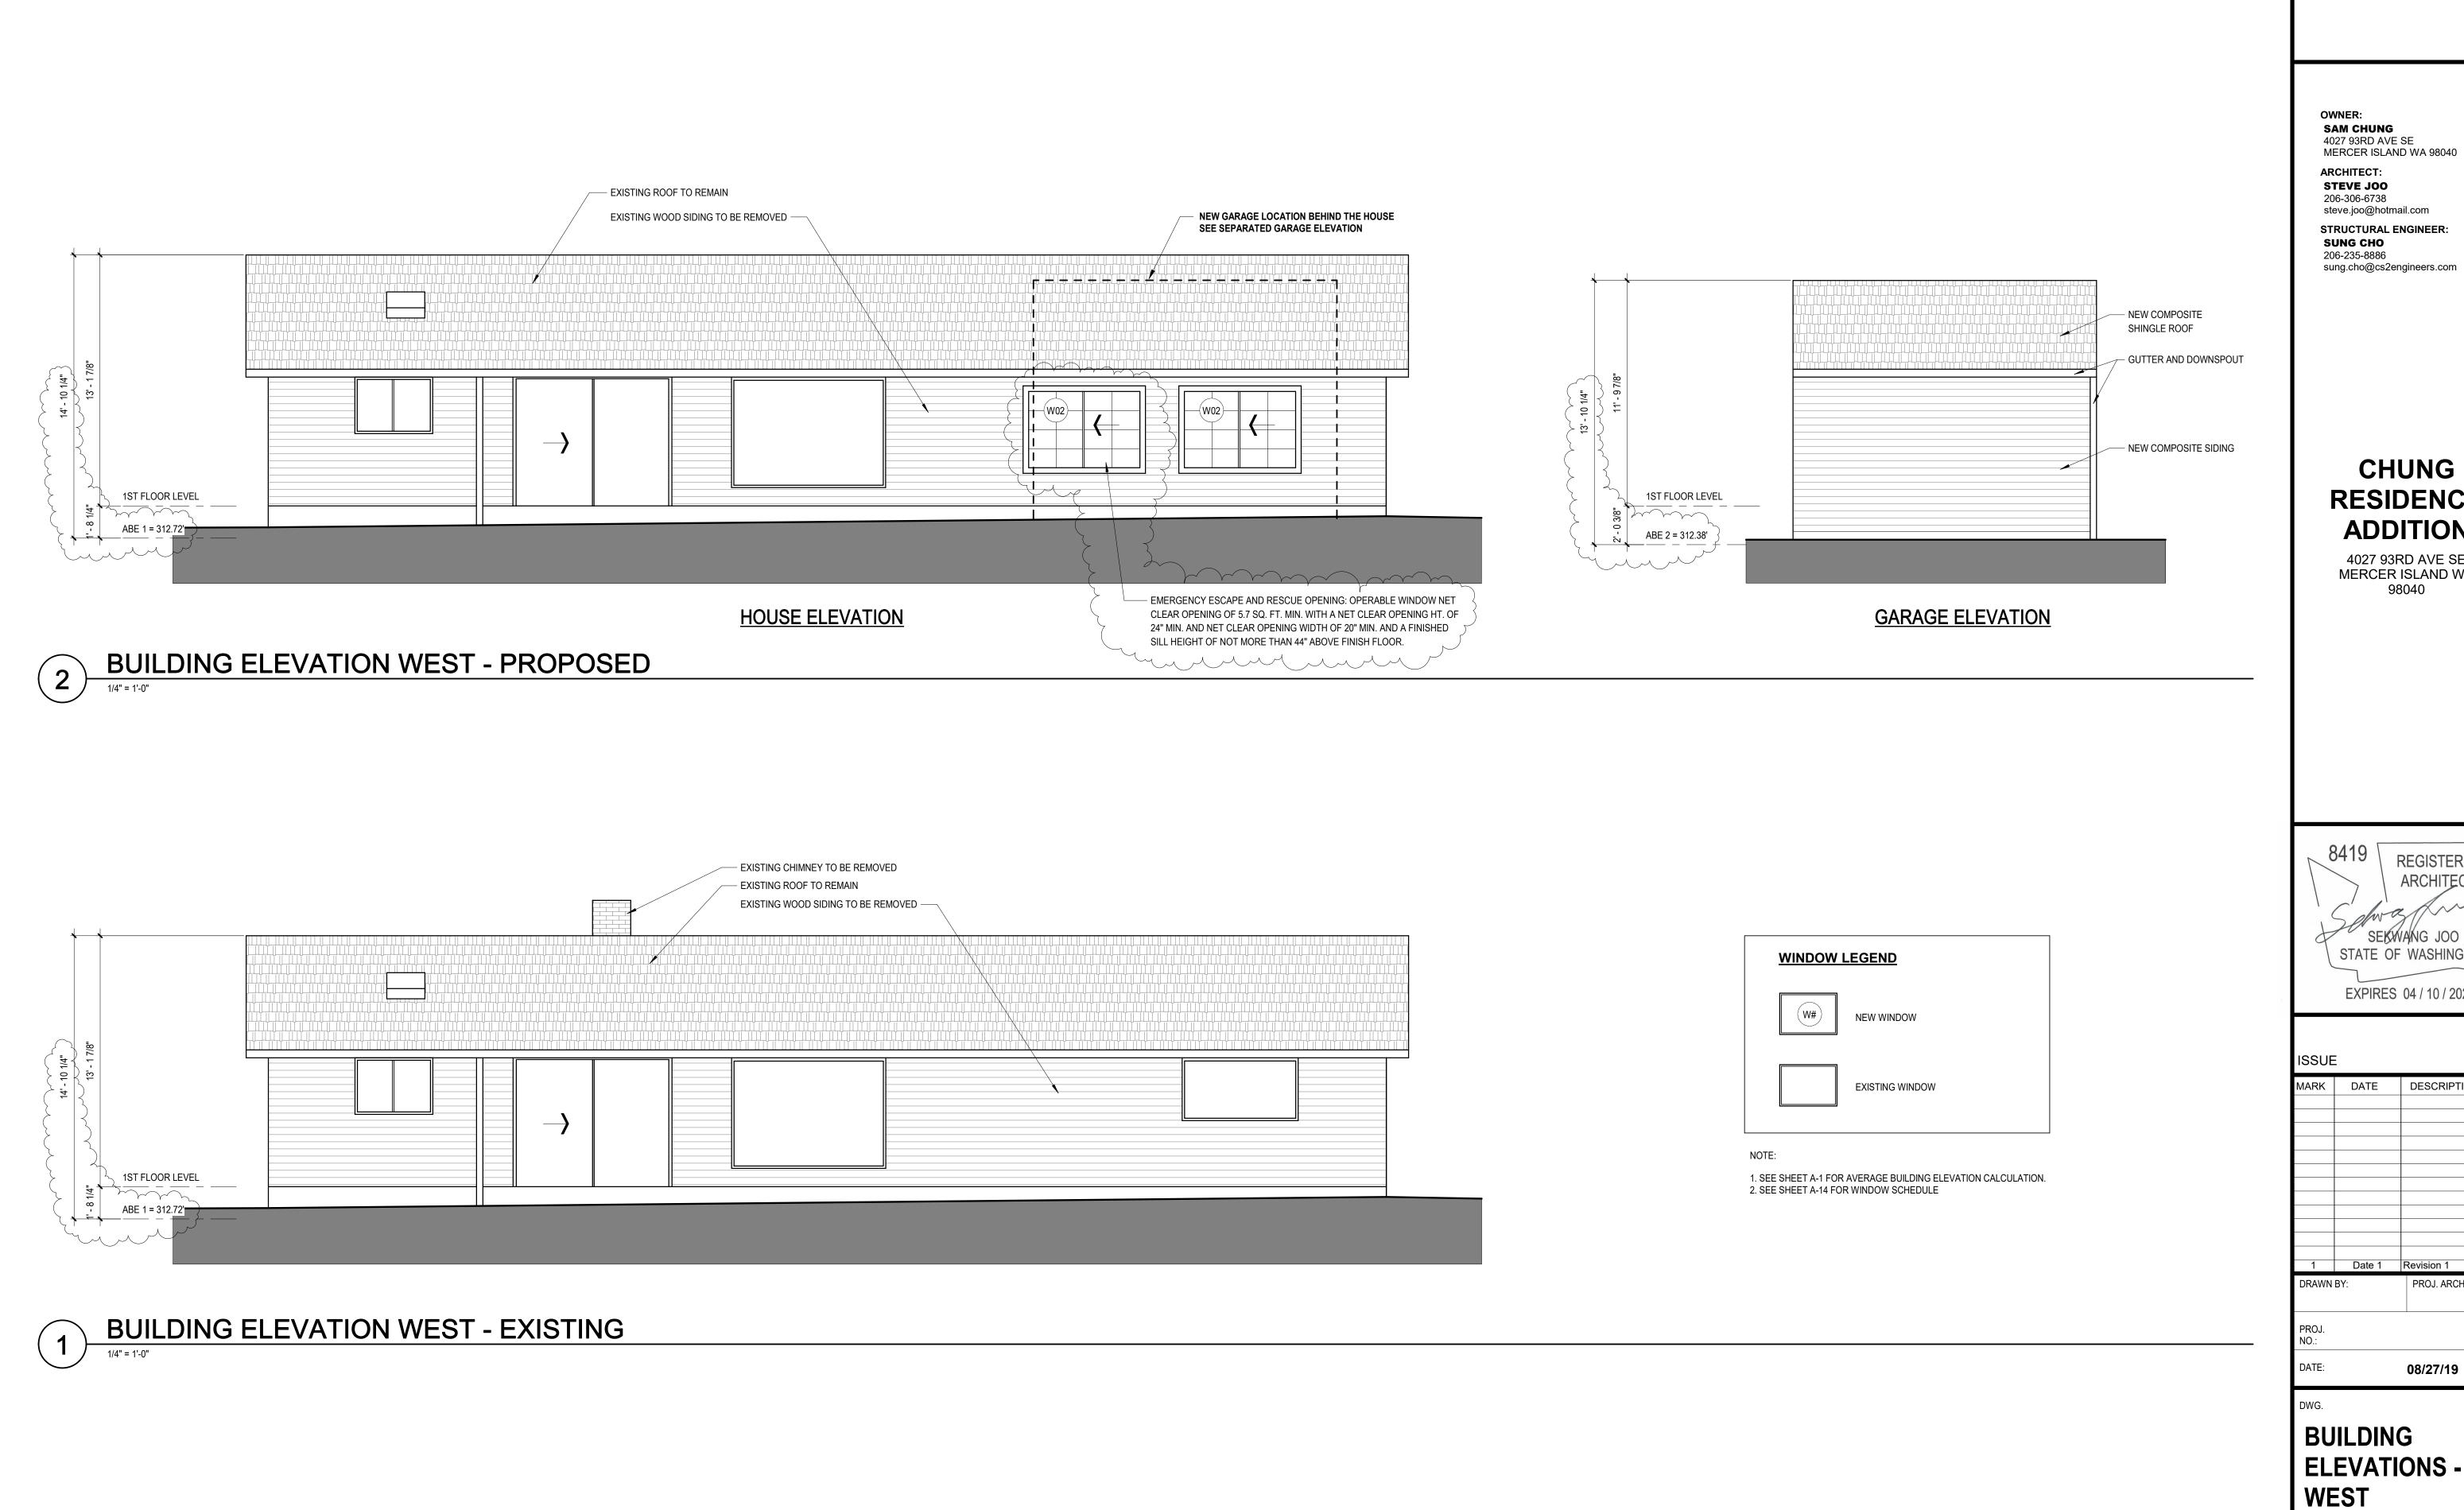
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1 Date 1 Revision 1

08/27/19

BUILDING **ELEVATIONS -**NORTH



CHUNG RESIDENCE **ADDITION**

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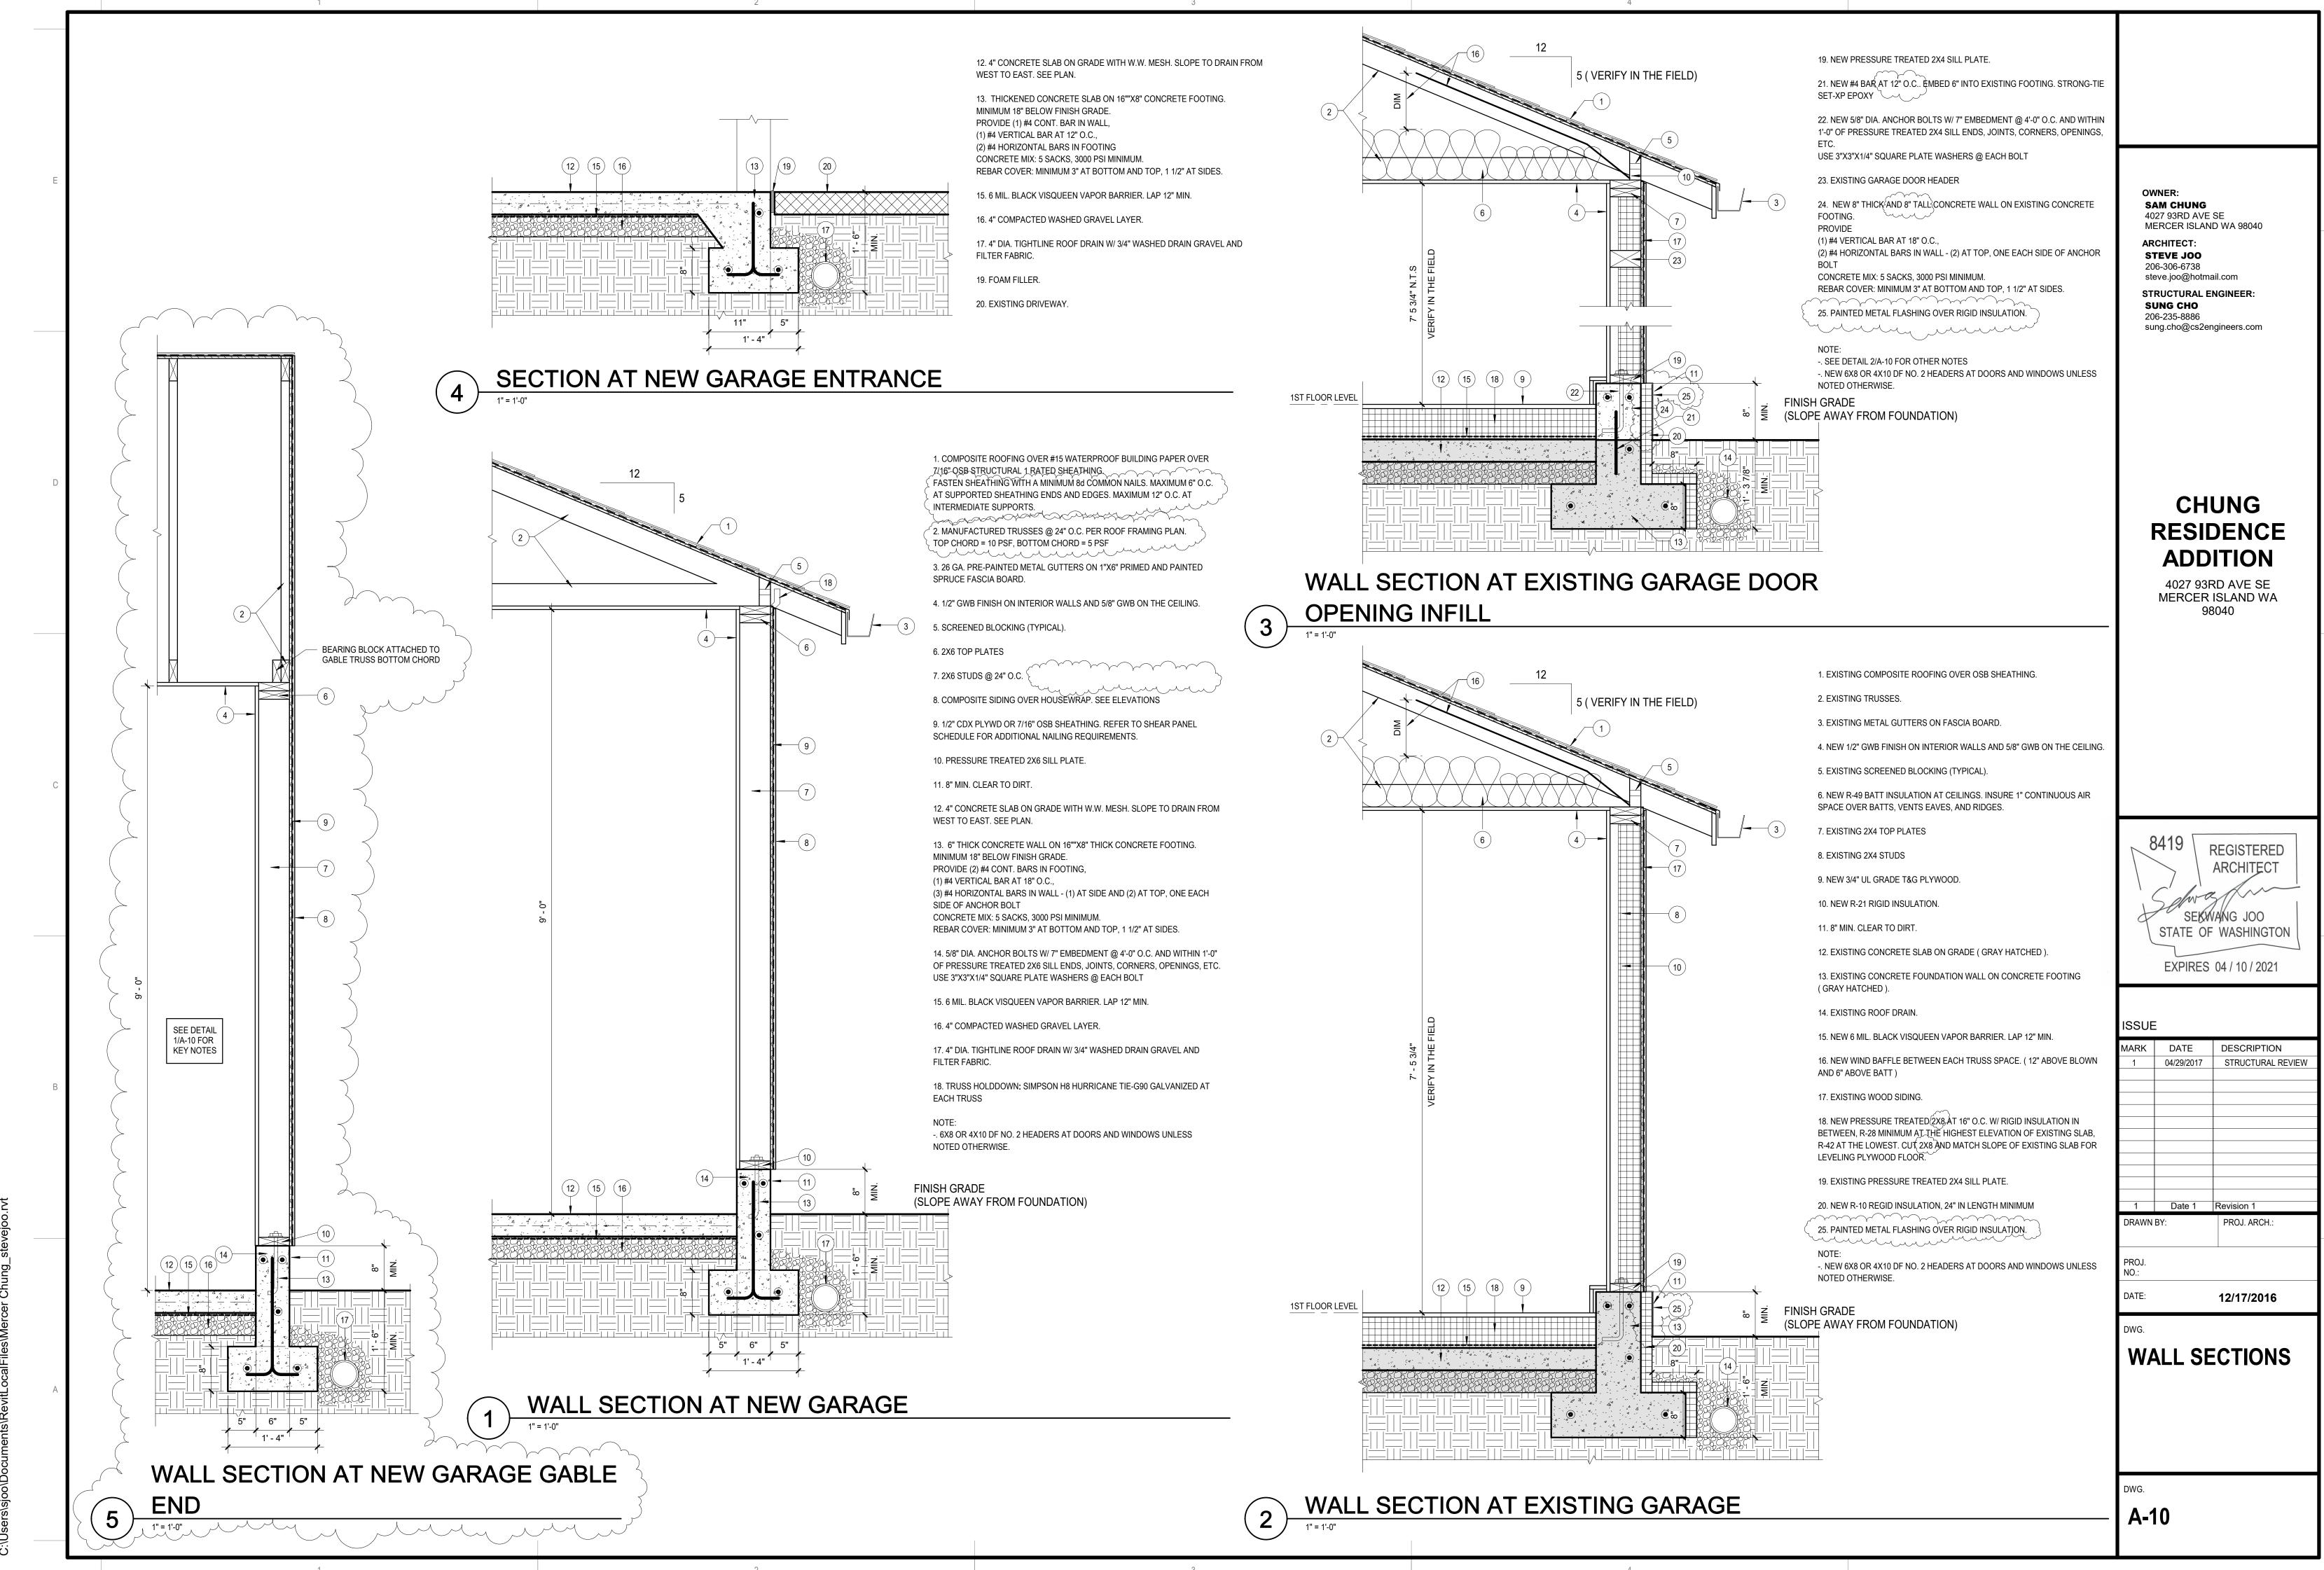
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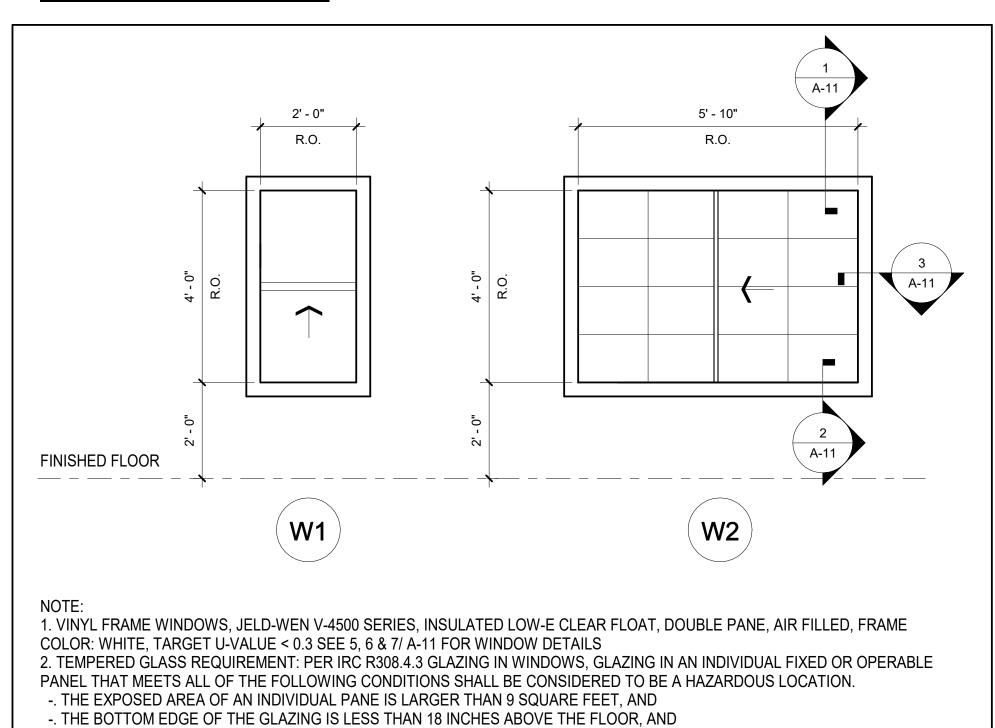
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BUILDING **ELEVATIONS -**




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WINDOW SCHEDULE




-. THE TOP EDGE OF THE GLAZING IS MORE THAN 36 INCHES ABOVE THE FLOOR, AND

-. ONE OR MORE WALKING SURFACES ARE WITHIN 36 INCHES, MEASURED HORIZONTALLY AND IN A STRAIGHT LINE

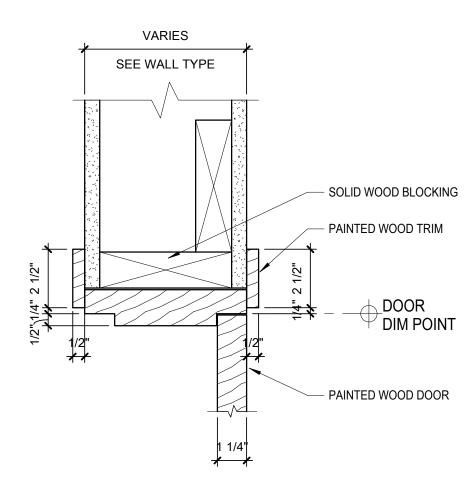


INTERIOR DOOR HEAD

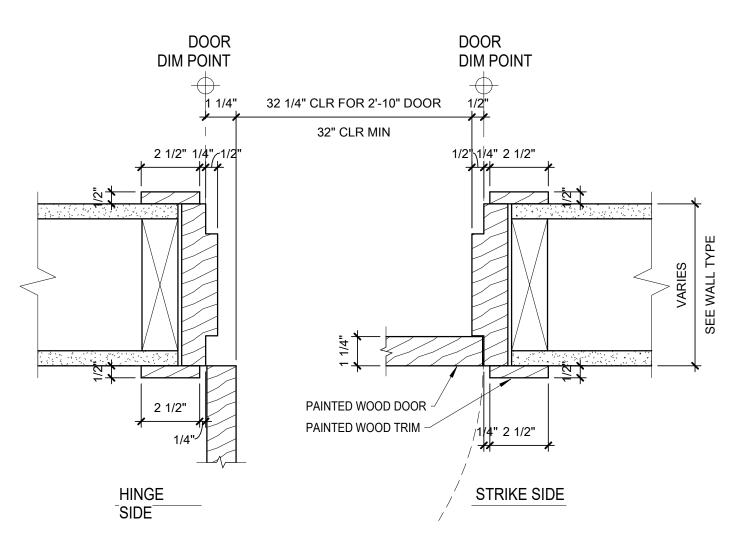


5 INTERIOR DOOR JAMB


3" = 1'-0"

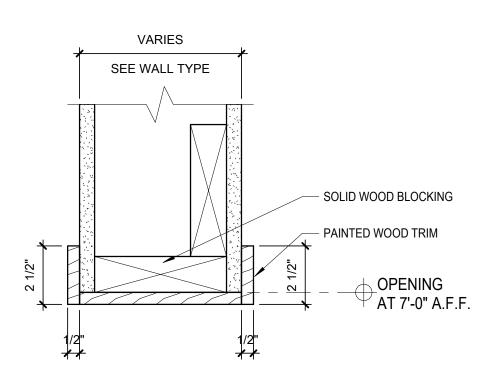


6 WALL OPENING HEAD & JAMB

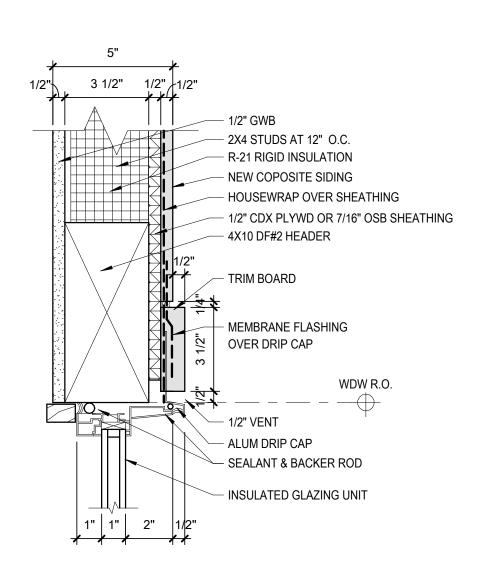

WDW HEAD AT EXTERIOR WALL

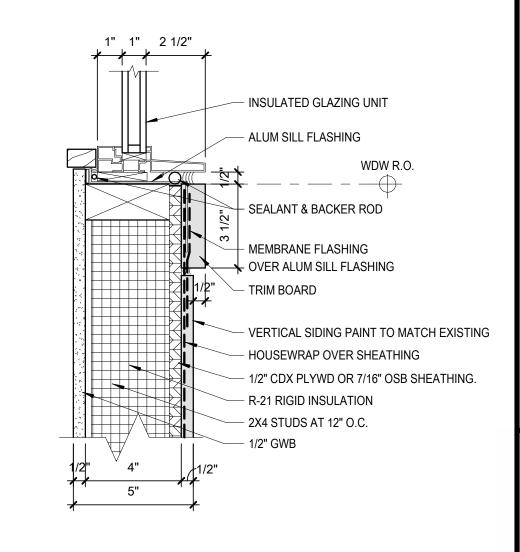

2 WDW SILL AT EXTERIOR WALL
3" = 1'-0"

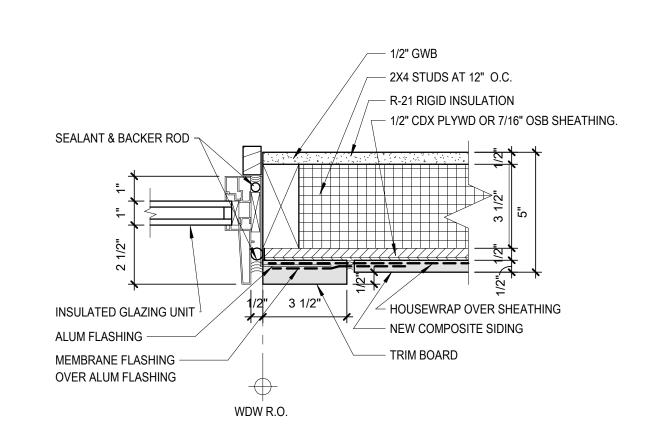

WDW JAMB AT EXTERIOR WALL

3" = 1'-0"

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> CHUNG **RESIDENCE ADDITION**

4027 93RD AVE SE MERCER ISLAND WA 98040

REGISTERED SEKWANG JOO STATE OF WASHINGTON EXPIRES 04 / 10 / 2021

MARK DATE DESCRIPTION DRAWN BY: PROJ. ARCH.: 01/04/17

DETAILS